


VARIOUS LOCATIONS -
HATCH & SCHURZ HALL
TUCK POINTING

Project CP252341
UNIVERSITY OF MISSOURI
FOR THE CURATORS OF THE UNIVERSITY OF MISSOURI
COLUMBIA, MISSOURI

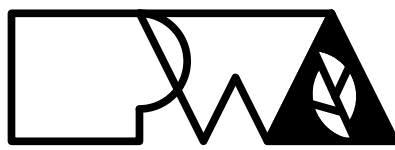


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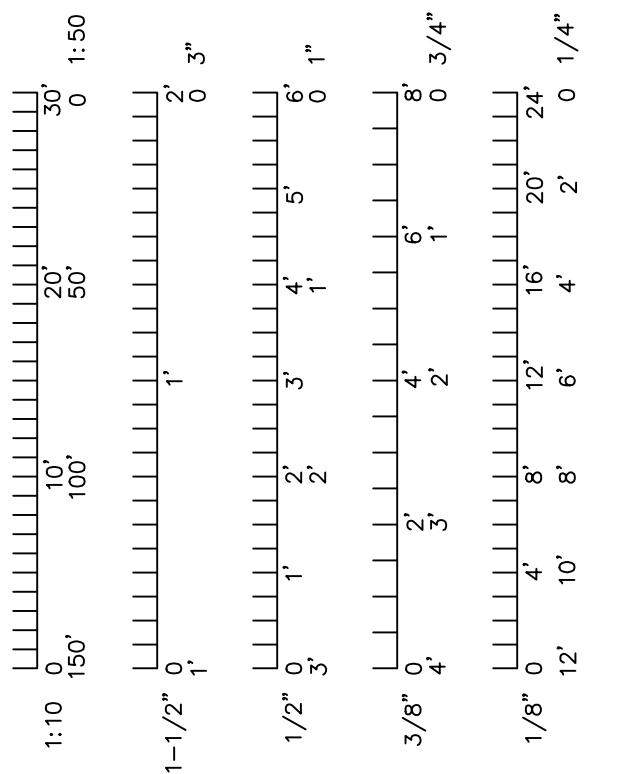



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Issued for Bid:
November 21, 2025


"I HEREBY CERTIFY THESE DRAWINGS AND/OR SPECIFICATIONS HAVE BEEN PREPARED BY ME, OR UNDER MY SUPERVISION. I FURTHER CERTIFY THAT TO THE BEST OF MY KNOWLEDGE THESE DRAWINGS AND/OR SPECIFICATIONS ARE AS REQUIRED BY AND IN COMPLIANCE WITH THE BUILDING CODES OF THE UNIVERSITY OF MISSOURI".


SIGNATURE
PW ARCHITECTS, INC.
ISSUED: 11/21/2025



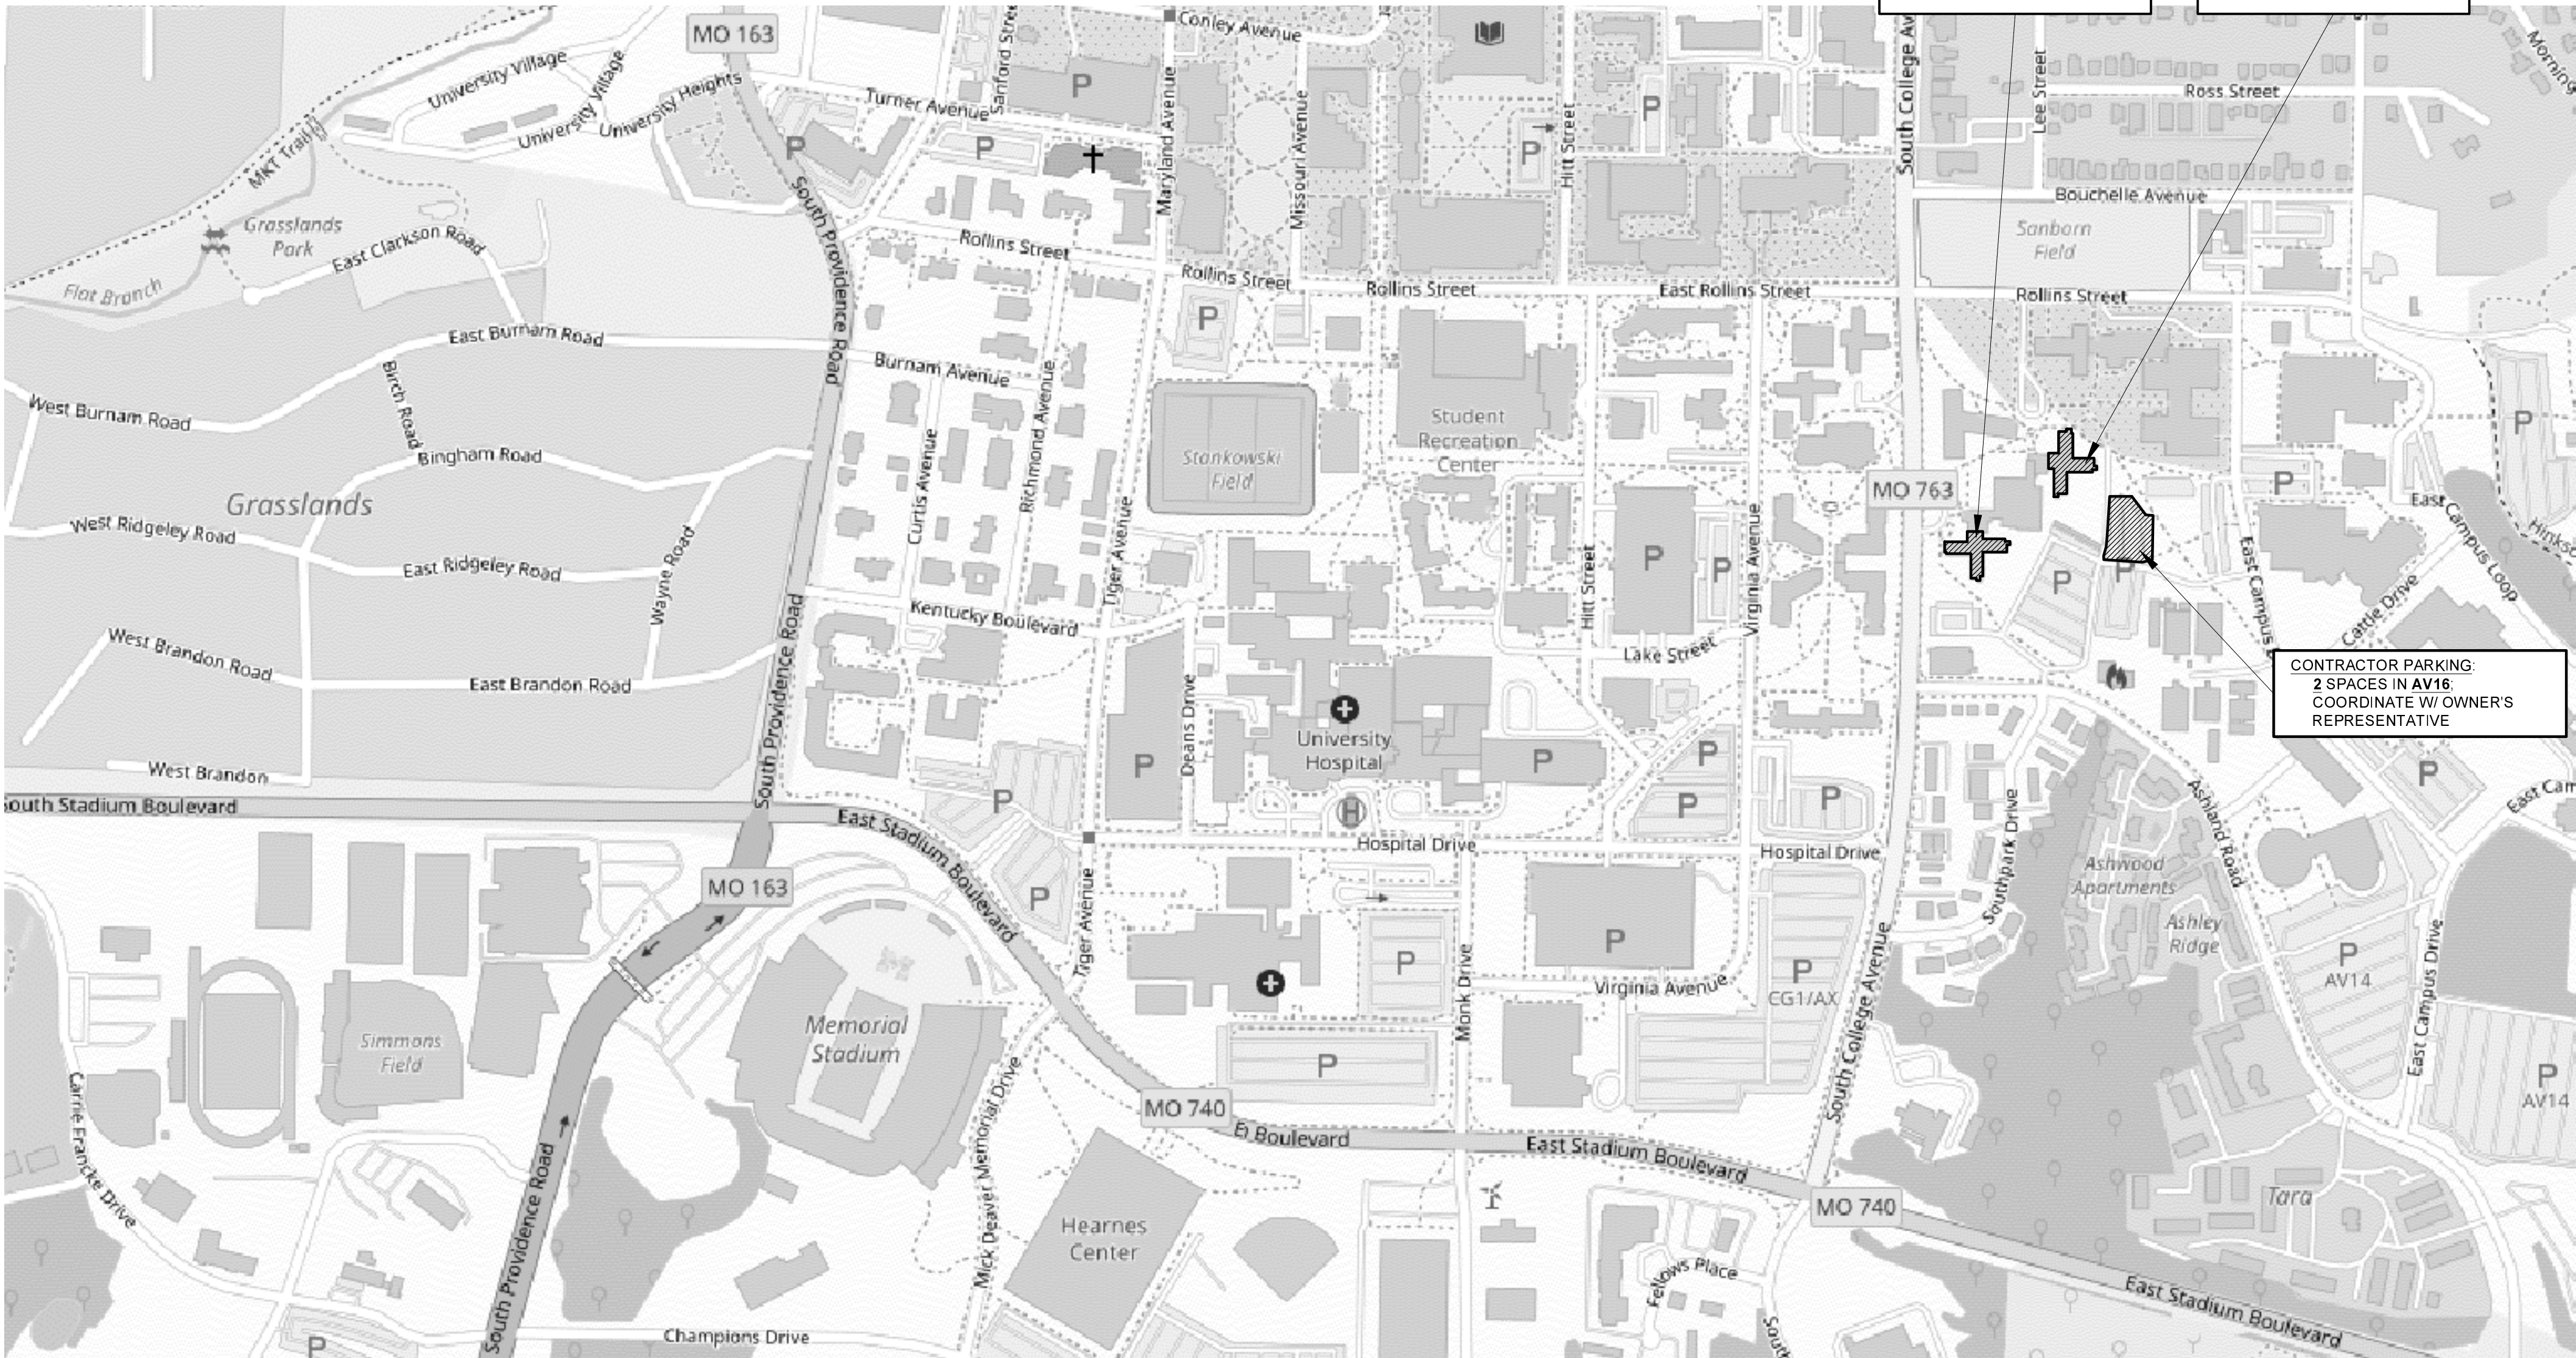

E1 LOCATION MAP - OVERALL
SCALE: N.T.S.

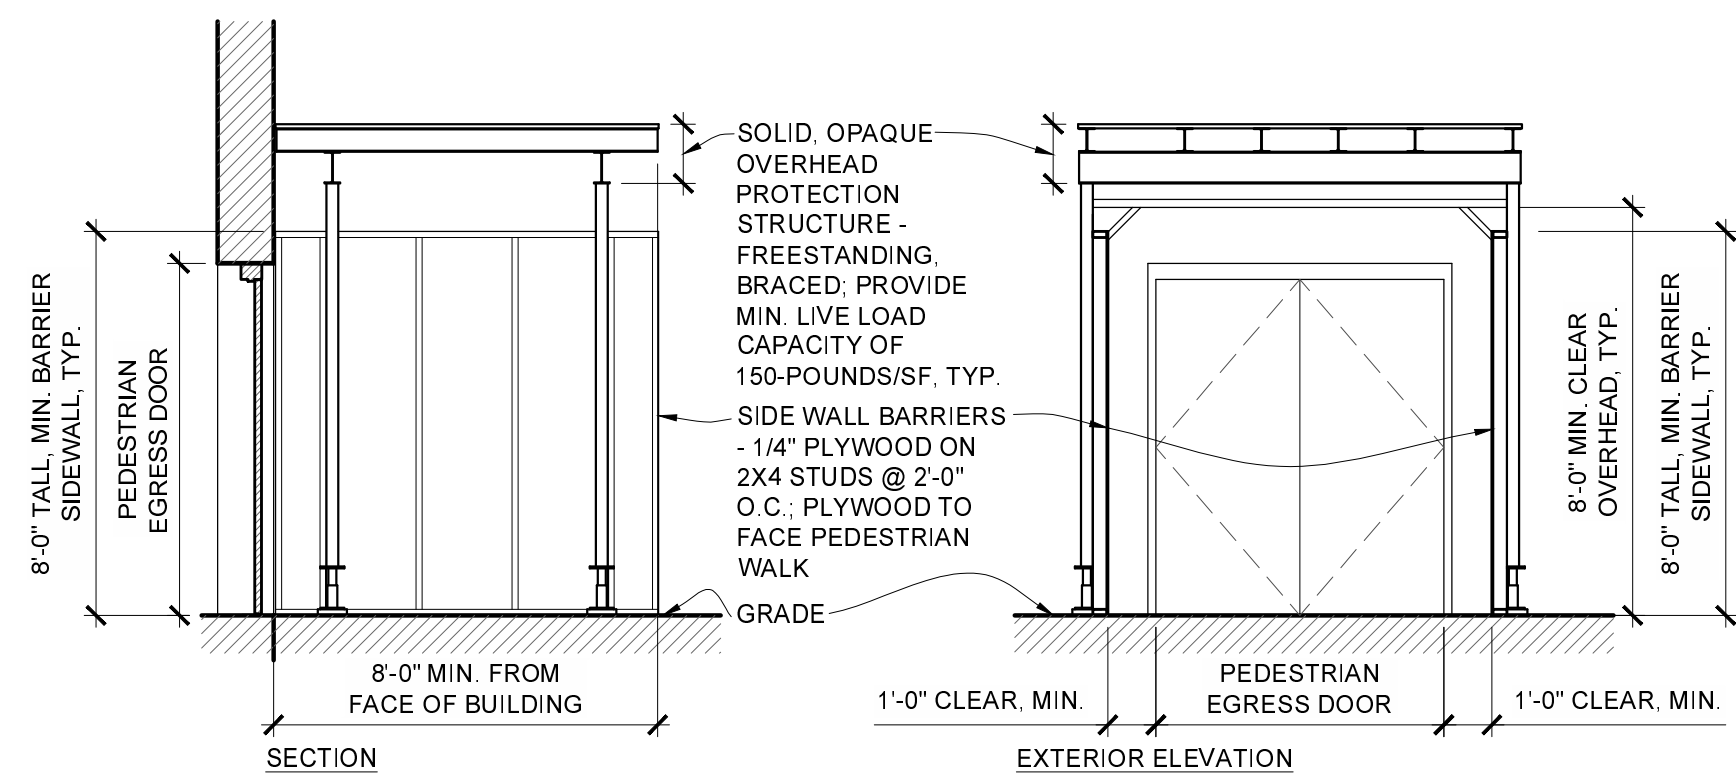

A3 TYPICAL OVERHEAD PROTECTION @ PEDESTRIAN ENTRIES
SCALE: 1/4" = 1'-0"



A8 HATCH HALL & SCHURZ HALL - LOCATION MAP
SCALE: N.T.S.

GENERAL

- G001 - COVER SHEET
G002 - LOCATION MAPS, LIST OF DRAWINGS, & LEGENDS
G003 - STAGING & TRAFFIC CONTROL: HATCH & SCHURZ

ARCHITECTURAL

- A130 - NEW WORK: PLANS: HATCH
A131 - NEW WORK: PLANS: SCHURZ
A201 - NEW WORK: ELEVATIONS: HATCH
A202 - NEW WORK: ELEVATIONS: HATCH
A203 - NEW WORK: ELEVATIONS: HATCH
A204 - NEW WORK: ELEVATIONS: HATCH
A205 - NEW WORK: ELEVATIONS: SCHURZ
A206 - NEW WORK: ELEVATIONS: SCHURZ
A207 - NEW WORK: ELEVATIONS: SCHURZ
A208 - NEW WORK: ELEVATIONS: SCHURZ
A501 - DETAILS
A502 - DETAILS
A701 - IMAGES

BUILDING CODE (IBC 2024)

THIS IS AN EXTERIOR MAINTENANCE AND/OR REPAIR PROJECT.

- NO NEW AREA IS BEING ADDED.
- THERE IS NO CHANGE TO THE EXISTING USE OR OCCUPANCY OF ANY OF THE BUILDINGS.
- THERE IS NO CHANGE TO EGRESS.

SPECIAL INSPECTIONS (IBC 1704): NO SPECIAL INSPECTIONS ARE REQUIRED ON THIS PROJECT.

DEFERRED SUBMITTALS: NO DEFERRED SUBMITTALS ARE REQUIRED ON THIS PROJECT.

J13 LIST OF DRAWINGS

SCALE: N.T.S.

LARGE SCALE		SMALL SCALE	
BRICK MASONRY UNIT			PLAN, SECTION
CONCRETE MASONRY UNIT			ELEVATION
CONCRETE			PLAN, SECTION
GROUTED AREA OF CMU/CAVITY DOOR FRAME			PLAN, SECTION
MISCELLANEOUS ITEMS AS NOTED ON EACH SHEET			PLAN, SECTION, ELEVATION
INSULATION			PLAN, SECTION
ROOF SHINGLES			PLAN, ELEVATION
CONTINUOUS WOOD FRAMING			PLAN, SECTION
WOOD BLOCKING			PLAN, SECTION
PLYWOOD			PLAN, SECTION
EXISTING BUILDING			PLAN, SECTION

F13 MATERIAL LEGEND

SCALE: N.T.S.

DRAWING BULLET WITH NORTH ARROW		DRAWING BULLET WITHOUT NORTH ARROW	
	DRAWING TITLE SCALE: XX" = 1'-0"		DRAWING TITLE SCALE: XX" = 1'-0"
ELEVATION BULLETS		PLANE/ELEVATION DETAIL BULLET	
	GRID REFERENCE SHEET NUMBER		GRID REFERENCE SHEET NUMBER
PHOTOGRAPH BULLETS		SECTION BULLET	
	GRID REFERENCE SHEET NUMBER		GRID REFERENCE ALWAYS ON TOP SHEET NUMBER
SCOPE OF WORK BULLET		NORTH ARROW	
WINDOW BULLET	DOOR BULLET	PHOTOS	
			GRID REF. ON TOP VIEW DIRECTION SHEET NO.
REVISION NOTE	GENERAL NOTE	COLUMN LINE BULLETS	
BENCHMARK BULLET		SPOT ELEV. BULLETS	
			TC - TOP OF CURB TG - TOP OF GRADE TW - TOP OF WALL TP - TOP OF PAVING

A13 SYMBOL LEGEND
SCALE: N.T.S.

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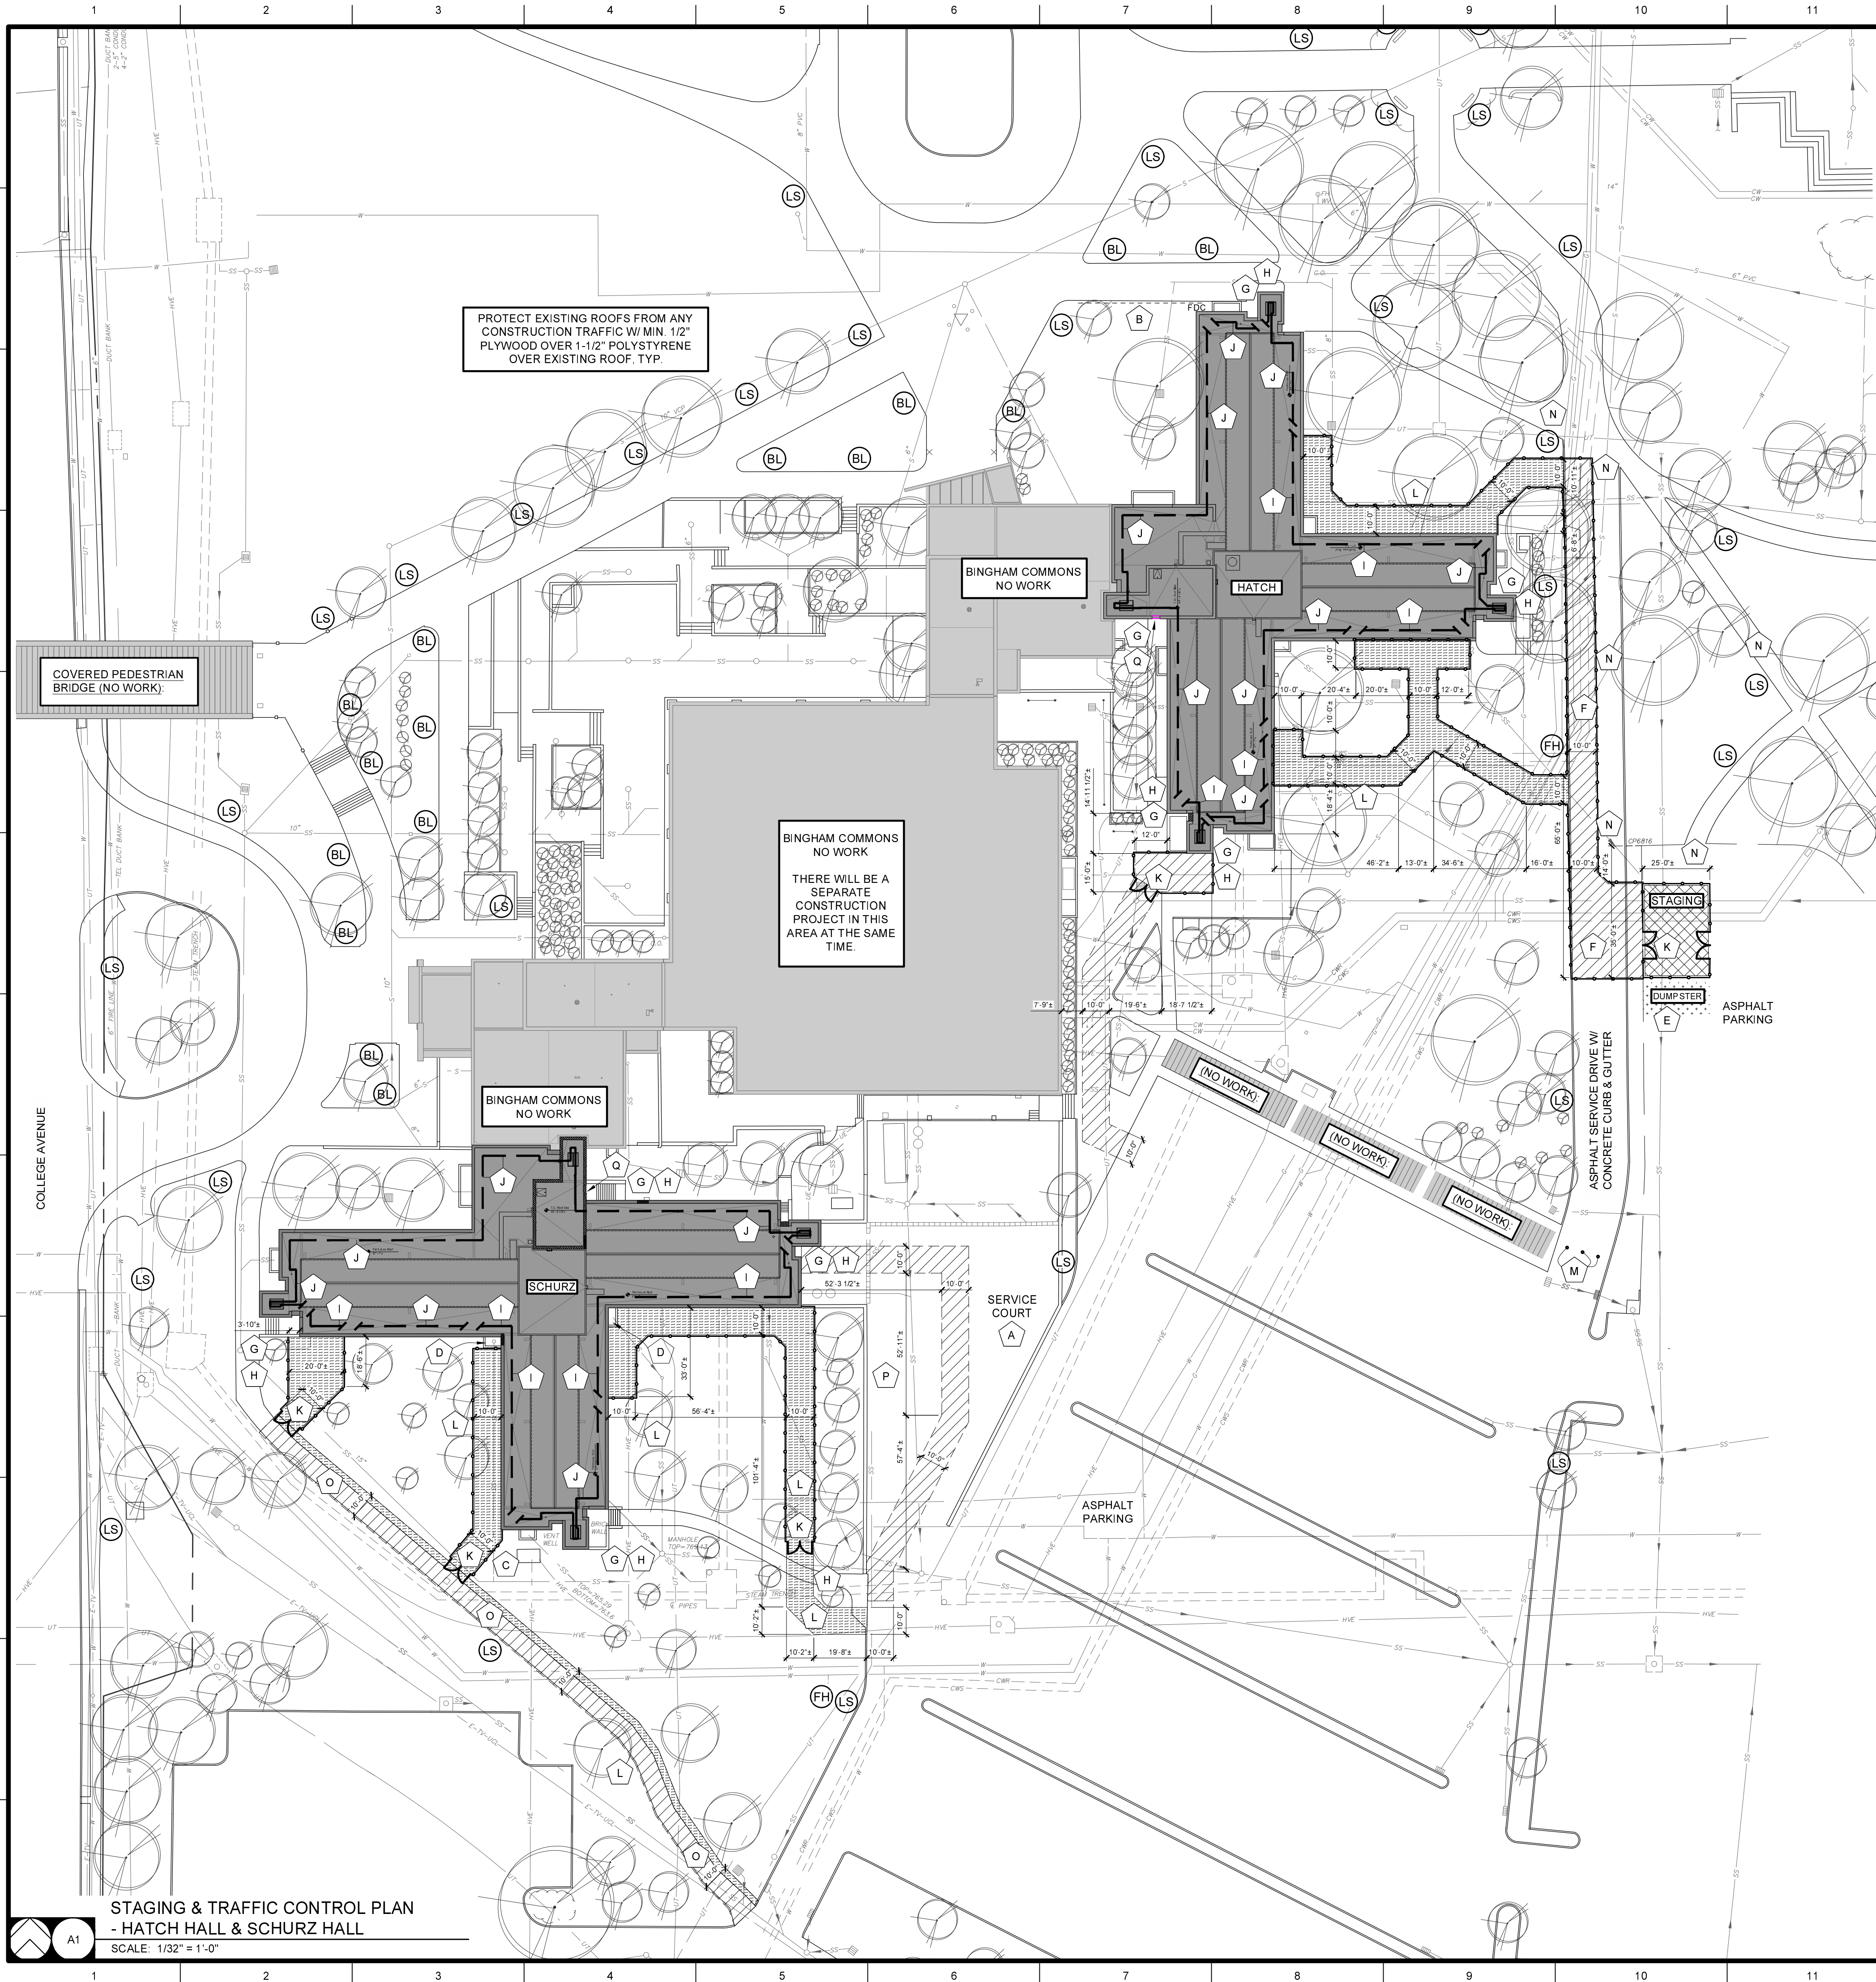
Project CP252341
VARIOUS LOCATIONS -
HATCH & SCHURZ HALL
TUCK POINTING
COLUMBIA, MO
University of Missouri
For: The Curators of the University of Missouri

Drawn: ER
Checked: ER
Project Number: 202509
CAD File Name (Number): G002.DWG

Drawing Title:
LOCATION MAPS, LIST OF DRAWINGS, & LEGENDS

No.	Revisions:	Date:

Submission Date: 2025.11.21
Plot Date: 2025.11.21
Drawing Number: G002



STAGING & TRAFFIC CONTROL PLAN
- HATCH HALL & SCHURZ HALL
SCALE: 1/32" = 1'-0"

SCOPE OF WORK NOTES

- A EXISTING SERVICE COURT MAINTAIN OPEN WITH UNRESTRICTED ACCESS FOR DURATION OF PROJECT. EXISTING BIKE RACKS TO REMAIN
- B EXISTING TRANSFORMER TO REMAIN - PROTECT.
- C EXISTING AREA WELL/ VENTILATION GRILLE. PROTECT DURING CONSTRUCTION. RESTRICT LOADING AS DIRECTED BY OWNER. VEHICULAR LOADING NOT ALLOWED.
- D CONTRACTOR DUMPSTER LOCATION. FINAL LOCATION TO BE COORDINATED WITH OWNER.
- E FOLLOW EXISTING ACCESS ROAD.
 - FENCING MUST BE REMOVED FROM ACCESS ROAD DURING MOVE-IN DATES. SEE SPECIAL SCHEDULING NOTES BELOW.
- F EXISTING BUILDING ENTRY TO REMAIN OPEN. PROVIDE OVERHEAD PROTECTION WHILE WORKING ABOVE THIS ENTRY. SEE A3 / G002 FOR TYPICAL OVERHEAD PROTECTION DETAIL.
- G EXISTING WALKWAY TO BE AVAILABLE FOR PEDESTRIAN USE. COORDINATE ANY TEMP. CLOSURE WITH OWNER'S REPRESENTATIVE. IF CLOSED, PROVIDE TEMPORARY FENCING AND / OR BARRICADES TO PREVENT USE.
- H CONSTRUCTION ACCESS TO THIS SIDE OF THE BUILDING IS TO BE EITHER:
 - FROM THE GROUND. OR
 - FROM THE ROOF VIA SWING STAGE. NOTE ROOF PROTECTION REQUIREMENTS. OR
 - FROM SCAFFOLDING. SET MAXIMUM 4'-0" OFF THE FACE OF BUILDING.
- I CONSTRUCTION ACCESS AT THIS LOCATION IS TO BE:
 - FROM THE ROOF VIA SWING STAGE. NOTE ROOF PROTECTION AND OVERHEAD PROTECTION REQUIREMENTS.
- J PROVIDE 9'-0" WIDE MOVABLE GATE IN CONSTRUCTION FENCE.
- K AT TEMPORARY ACCESS LANES AND CONTRACTOR STAGING, AT DRIPLINE OF TREES TO REMAIN. PROTECT EXISTING TREE ROOTBALL AND ROOT SYSTEM. MINIMIZE WEIGHT & VEHICULAR TRAFFIC.
- L REMOVABLE BOLLARDS. COORDINATE W/ OWNER'S REPRESENTATIVE FOR TEMPORARY REMOVAL.
- M MAINTAIN OPEN FOR PEDESTRIAN TRAFFIC.
- N FOLLOW EXISTING 8'-0" WIDE SIDEWALK. PROVIDE ALTERNAMATS ON NORTH EDGE OF SIDEWALK @ LANDSCAPING. COORDINATE LOCATION OF ALTERNAMATS ON SITE W/ OWNER'S REPRESENTATIVE.
- O OWNER MAINTENANCE & SERVICE VEHICLE PARKING. MAINTAIN ACCESS EXCEPT AS COORDINATED W/ OWNER'S REPRESENTATIVE.
- P CONTRACTOR PERSONNEL ACCESS TO ROOF:
 - CONTRACTOR MAY USE THE EXISTING INTERIOR STAIR OR ELEVATOR AT THIS LOCATION ONLY.
 - LOCATIONS OF APPROXIMATELY ONE (1) LINEAR FOOT PER LOCATION. LOCATIONS WILL BE RANDOMLY SELECTED BY THE OWNER'S REPRESENTATIVE. THE WORK WILL BE CHECKED BY THE OWNER'S REPRESENTATIVE FOR COMPLIANCE WITH THE CONTRACT DOCUMENTS IN ACCORDANCE TO ASTM C1193. IF DEFECTIVE WORK IS FOUND, FURTHER TESTS MAY BE REQUIRED AT NO ADDITIONAL COST TO THE OWNER. IF ANY TEST SECTION REVEALS NON-COMPLYING WORK, REMOVE ALL ADJACENT SEALANT WORK TO THE POINT WHERE WORK IS FOUND IN COMPLIANCE. RE-SEAL PER THE CONTRACT DOCUMENTS. IF MORE THAN FOUR (4) TESTS FAIL TO MEET THE CONTRACT DOCUMENT REQUIREMENTS, THE CONTRACTOR MAY BE REQUIRED TO RE-SEAL THE ENTIRE BUILDING OR SELECTED SECTIONS OF THE BUILDING AT NO ADDITIONAL COST TO THE OWNER. PROVIDE LIFTS OR OTHER ACCEPTABLE MEANS OF ACCESS TO THE WORK.
- Q

PROTECT EXISTING BURIED UTILITIES FROM DAMAGE INCLUDING EXCESSIVE WHEEL LOADING FROM LIFT EQUIPMENT.

ABOVE GROUND EQUIPMENT SHALL BE PROTECTED FROM DAMAGES INCLUDING FALLING DEBRIS AND INADVERTENT COATING.

CONTRACTOR SHALL BE RESPONSIBLE FOR VERIFYING, COORDINATING, PATCHING, AND REPAIRING ALL EXISTING ITEMS TO REMAIN WHERE AFFECTED BY REMOVED ITEMS. SPECIFIC INSTANCES OF PATCHING MAY NOT BE NOTED ON DRAWINGS.

OWNER TO PRUNE EXISTING TREES/VEGETATION TO PROVIDE MIN. 4'-0" CLEAR @ PERIMETER OF BUILDING. COORDINATE REMOVAL OF ANY EXISTING LANDSCAPING / TREES WITH OWNER'S REPRESENTATIVE. MU LANDSCAPING SERVICES WILL REMOVE AND/OR PRUNE BACK TREES IN COORDINATION WITH OWNER'S REPRESENTATIVE.

UNLESS SPECIFICALLY STATED OR SHOWN, ALL WORK SHALL APPLY TO EXTERIOR OF BUILDING ONLY.

SPECIAL SCHEDULING

MAY 8-16, 2026	QUIET WEEK - NO LOUD WORK
MAY 19, 2026	LAST DAY OF OCCUPANCY - HATCH & SCHURZ HALLS
AUG. 7, 2026	STAFF MOVE-IN
AUG. 15, 2026	STUDENT MOVE-IN: NO WORK
AUG. 19, 2026	STUDENT MOVE-IN: NO WORK
AUG. 20, 2026	STUDENT MOVE-IN: NO WORK
AUG. 24, 2026	FIRST DAY OF CLASSES.

CONSTRUCTION SEQUENCING NOTES

REPAIR WORK ON THE BUILDING IS TO BE COMPLETED IN THE FOLLOWING ORDER. ON COMPLETION OF EACH STAGE OF WORK, OBTAIN APPROVAL FROM THE OWNER'S REPRESENTATIVE PRIOR TO PROCEEDING TO THE NEXT WORK AREA.

- SCHURZ HALL:**
- WORK AREA 1: NORTHWEST ELEVATIONS
 - WORK AREA 2: SOUTHWEST ELEVATIONS
 - WORK AREA 3: SOUTHEAST ELEVATIONS
 - WORK AREA 4: NORTHEAST ELEVATIONS

- HATCH HALL:**
- WORK AREA 5: SOUTHEAST ELEVATIONS
 - WORK AREA 6: SOUTHWEST ELEVATIONS
 - WORK AREA 7: NORTHEAST ELEVATIONS
 - WORK AREA 8: NORTHWEST ELEVATIONS

WORK AREA 6 MAY ONLY BE ACCESSED FROM GROUND LEVEL DURING JUNE AND JULY UNLESS OTHERWISE ARRANGED WITH THE OWNER'S REPRESENTATIVE.


FENCING MUST BE REMOVED FROM WORK AREAS 1 THROUGH 6. PRIOR TO STUDENT MOVE-IN

GENERAL SITE PLAN & STAGING NOTES

- FIELD VERIFICATION: INFORMATION CONTAINED IN THESE DRAWINGS IS BASED ON EXISTING DOCUMENTS. THE INFORMATION CONTAINED HEREIN MAY REQUIRE ADJUSTMENTS OR MODIFICATIONS TO CONFORM WITH EXISTING CONDITIONS IN CASES WHERE CHANGES IN DETAILS ARE NECESSARY. THESE DRAWINGS CONVEY THE DESIGN INTENT ONLY.
- FIELD VERIFY ALL DIMENSIONS AND CONDITIONS PRIOR TO EXECUTING ANY WORK. NOTIFY OWNER'S REPRESENTATIVE OF ANY DIMENSIONS OR WORK DIFFERING FROM THAT SHOWN FOR CLARIFICATION BY THE OWNER'S REPRESENTATIVE PRIOR TO PROCEEDING WITH THE WORK.
- ALL DIMENSIONS ARE TO FACE OF STUD, OR MASONRY, UNLESS OTHERWISE NOTED.
- REMOVE ALL EXISTING BUILDING ELEMENTS AS NOTED AND THOSE THAT WOULD INTERFERE WITH THE INSTALLATION OF NEW WORK. VERIFY WITH OWNER'S REPRESENTATIVE REMOVAL OF ANY ITEMS NOT NOTED FOR DEMOLITION.
- PROTECT ALL ADJACENT AREAS, INCLUDING LANDSCAPING NOT DESIGNATED FOR WORK, FROM DAMAGE AS A RESULT OF THIS WORK. DAMAGED ITEMS WILL BE REPAIRED BY THE OWNER; THE CONTRACTOR WILL BE RESPONSIBLE FOR THE COST OF THE REPAIRS.
- FLASHING DETAILS SHOWN ARE BASED ON STANDARD DETAILS FROM THE SHEET METAL AND AIR CONDITIONING CONTRACTORS NATIONAL ASSOCIATION (SMACNA). NOTIFY OWNER'S REPRESENTATIVE OR FABRICATOR OF INSTALLATION REQUIREMENTS THAT DIFFER FROM THOSE SHOWN. DO NOT PROCEED WITH WORK UNTIL INSTRUCTIONS ARE RECEIVED FROM OWNER'S REPRESENTATIVE.
- PERFORM ALL TUCKPOINTING WORK IN ACCORDANCE WITH THE BRICK INDUSTRY ASSOCIATION (BIA) TECH NOTES PUBLICATION 46, AND THE CONTRACT DOCUMENTS, WHICHEVER IS THE MOST STRINGENT.
- NO CONSTRUCTION TRAFFIC IS ALLOWED ON THE ROOF WITHOUT PROTECTION BOARDS AS DEFINED IN THE PROJECT DOCUMENTS OR AS OTHERWISE PERMITTED BY THE OWNER'S REPRESENTATIVE.
- PROTECT ALL AREAS THAT INTERFACE WITH SCAFFOLDING SUCH AS COPINGS, FLASHINGS, AND OTHER LIKE ITEMS.
- PROTECT ALL BUILDING ENTRANCES WHEN DOING WORK OVERHEAD. SEE A3 / G002 FOR TYPICAL OVERHEAD PROTECTION DETAIL.
- COORDINATE ALL REQUIRED UTILITIES WITH OWNER.
- DO NOT SCALE DRAWINGS - WHERE DIMENSIONAL DISCREPANCIES ARE ENCOUNTERED NOTIFY ARCHITECT PRIOR TO PROCEEDING WITH THE WORK.
- INDEPENDENT TESTING AGENCY MAY BE HIRED BY THE OWNER TO CUT OUT AND REMOVE INSTALLED SEALANT JOINTS IN SIX (6) LOCATIONS OF APPROXIMATELY ONE (1) LINEAR FOOT PER LOCATION. LOCATIONS WILL BE RANDOMLY SELECTED BY THE OWNER'S REPRESENTATIVE. THE WORK WILL BE CHECKED BY THE OWNER'S REPRESENTATIVE FOR COMPLIANCE WITH THE CONTRACT DOCUMENTS IN ACCORDANCE TO ASTM C1193. IF DEFECTIVE WORK IS FOUND, FURTHER TESTS MAY BE REQUIRED AT NO ADDITIONAL COST TO THE OWNER. IF ANY TEST SECTION REVEALS NON-COMPLYING WORK, REMOVE ALL ADJACENT SEALANT WORK TO THE POINT WHERE WORK IS FOUND IN COMPLIANCE. RE-SEAL PER THE CONTRACT DOCUMENTS. IF MORE THAN FOUR (4) TESTS FAIL TO MEET THE CONTRACT DOCUMENT REQUIREMENTS, THE CONTRACTOR MAY BE REQUIRED TO RE-SEAL THE ENTIRE BUILDING OR SELECTED SECTIONS OF THE BUILDING AT NO ADDITIONAL COST TO THE OWNER. PROVIDE LIFTS OR OTHER ACCEPTABLE MEANS OF ACCESS TO THE WORK.
- LEAVE AREA CLEAN AND DEBRIS-FREE AT END OF EACH DAY.
- UNLESS OTHERWISE NOTED OR SHOWN, DIMENSIONS ARE PROVIDED FOR PURPOSES OF OBTAINING APPROXIMATE QUANTITIES ONLY. FIELD VERIFY ALL QUANTITIES.
- OFFLOAD ALL MATERIALS AT DESIGNATED AREA. MOVE ALL DELIVERY VEHICLES FROM SITE AFTER OFFLOADING.

STAGING PLAN KEY

- LS EXISTING POLE-MOUNTED SITE LIGHTING TO REMAIN; PROTECT DURING CONSTRUCTION ACTIVITIES
- BL EXISTING BOLLARD/POST- MOUNTED SITE LIGHTING TO REMAIN; PROTECT DURING CONSTRUCTION ACTIVITIES
- FH EXISTING FIRE HYDRANT
- F EXISTING FIBER OPTIC / TELECOMMUNICATIONS LINE PULL BOX
- FDC FIRE DEPARTMENT CONNECTION
- STAGING AREA - COVER SOIL WITH DOUBLE LAYER OF ALTERNAMATS.
- ACCESS LANES @ EXISTING LANDSCAPING; COORDINATE FINAL LOCATION(S) WITH OWNER'S REPRESENTATIVE ON-SITE.
 - COVER SOIL WITH DOUBLE LAYER OF ALTERNAMATS (TYP.)
 - AT PROJECT COMPLETION REMOVE ALTERNAMATS.
- ACCESS LANES @ EXISTING PAVING; COORDINATE FINAL LOCATION(S) WITH OWNER'S REPRESENTATIVE ON-SITE.
 - LANDSCAPE SERVICES WILL TRIM EXISTING BRANCHES TO PROVIDE MIN. 12'-0" ABOVE GRADE VERTICAL CLEARANCE.
- CONTRACTOR DUMPSTER LOCATION
- LANDSCAPING ITEM TO REMAIN & PROTECT
- LANDSCAPING ITEM TO REMOVE
- CONSTRUCTION FENCE
- WATER LINE TO REMAIN. PROTECT
- ELECTRICAL TO REMAIN. PROTECT
- TELECOM TO REMAIN. PROTECT
- SANITARY TO REMAIN. PROTECT
- CHILLED WATER LINE TO REMAIN. PROTECT
- STORM SEWER TO REMAIN. PROTECT

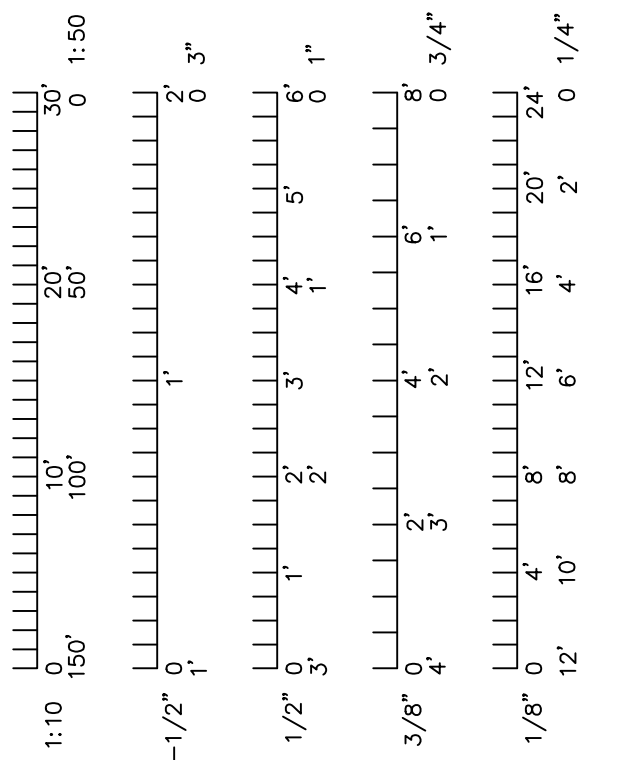


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M
Project CP252341
VARIOUS LOCATIONS -
HATCH & SCHURZ HALL
TUCK POINTING
COLUMBIA, MO
University of Missouri
For: The Curators of the University of Missouri

Drawn:	ER	Project Number:	202509
Checked:	ER	CAD File Name (Number):	G003.DWG
Drawing Title:	STAGING & TRAFFIC CONTROL: HATCH & SCHURZ		
No.	Revisions:	Date:	
Submission Date:	2025.11.21	Drawing Number:	G003
Plot Date:	2025.11.21		



- GENERAL NOTES**
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- SCOPE OF WORK NOTES & KEY**
- A** XX REPOINT DEFECTIVE EXISTING MORTAR JOINTS IN BRICK MASONRY - SEE: **A11** **A501** 'XX' = REPOINT XX%, OR REPOINT XX S.F.
 - B** REPOINT JOINTS AT DESIGNATED EXISTING LEDGE ANGLES. INSTALL NEW "RAKE AND SEAL" SEALANT JOINTS AND WEEPS AT 24 INCHES ON CENTER AT SAME. SEE: **E7** **A501** **A4** **A501** AND.
 - C** REMOVE EXISTING SEALANT AND BACKING MATERIAL AT DESIGNATED EXISTING MASONRY CONTROL JOINTS. INSTALL NEW SEALANT WITH BACKER ROD/BOND BREAKER. SEE: **E11** **A501**
 - D** REPLACE DESIGNATED DEFECTIVE BRICK. 'X' = QTY/AREA TO REPLACE.
 - E** REPOINT EXISTING JOINTS BETWEEN STONE MASONRY VENEER PANELS AT PARAPET. INSTALL NEW "RAKE AND SEAL" SEALANT JOINTS, TYP.: SEE: **E7** **A501** SIM.
 - F** REPOINT ALL EXISTING HEAD & BED JOINTS AT STONE COPING WITH NEW "RAKE AND SEAL" SEALANT JOINTS, TYP.: - SEE: **C7** **A501** **E4** **A501**
 - G** PATCH EXISTING STONE COPING WITH REPAIR MORTAR.
 - H** PATCH EXISTING STONE COPING WITH REPAIR MORTAR. LOCATION IS ON TOP &/OR INSIDE FACE OF PARAPET (CONCEALED IN THIS ELEVATION).
 - I** AT DESIGNATED PARAPET COPING STONE(S): REMOVE EXISTING STONE COPING. INSTALL NEW STAINLESS STEEL THROUGH-WALL FLASHING W/ COUNTER-FLASHING RECEIVER. REINSTALL EXISTING STONE COPING. REPOINT ALL JOINTS IN REINSTALLED STONE COPING WITH BACKING MATERIAL/BOND BREAKER AND SEALANT. INSTALL NEW WEEPS AT 24" ON CENTER AT BOTH FRONT AND REAR FACES OF STONE COPING. RESET EXISTING LOOSE TERMINATION BARS AT EXISTING B.U.R. CLEAN & SEAL STONE COPING - SEE: **A1** **A502** **G4** **A501**
 - J** WHERE REQUIRED, COORDINATE REMOVAL OF EXISTING ANTENNA MOUNTING BRACKETS WITH OWNER.
 - K** TEMPORARILY REMOVE & REINSTALL EXISTING LADDER MOUNTING BRACKETS.
 - L** REPOINT OPEN GAP AT EXISTING SEALANT JOINT WITH BACKER ROD/ BOND BREAKER & CONTINUOUS, TOOLED, SANDED SEALANT JOINT TO MATCH EXISTING.
 - M** REPAIR EXISTING DAMAGED BRICK FACE AT LIGHTNING CABLE PENETRATION W/ PATCHING MORTAR, POINT CABLE/ROD PENETRATION WITH SEALANT & BACKER.
 - N** REPOINT EXISTING SEALANT JOINT @ FLASHING REGLET.
 - O** REPLACE DAMAGED COPING STONE, POINT WITH NEW "RAKE AND SEAL" SEALANT JOINTS. TYP. - SEE: **A5** **A502** **A9** **A502** **F5** **A502** **F9** **A502** SIM. SIM. SIM. SIM.
 - P** REPLACE DAMAGED STONE PANEL(S) @ PARAPET; POINT WITH NEW "RAKE AND SEAL" SEALANT JOINTS. TYP. - SEE: **A5** **A502** **A9** **A502** **F5** **A502** **F9** **A502** SIM. SIM. SIM. SIM.
- CONTRACTOR SHALL BE RESPONSIBLE FOR VERIFYING, COORDINATING, PATCHING, AND REPAIRING ALL EXISTING ITEMS TO REMAIN WHERE AFFECTED BY REMOVED ITEMS. SPECIFIC INSTANCES OF PATCHING MAY NOT BE NOTED ON DRAWINGS**
- UNLESS SPECIFICALLY STATED OR SHOWN, ALL WORK SHALL APPLY TO EXTERIOR OF BUILDING ONLY**
- REMOVE AND RE-INSTALL ALL ITEMS THAT WOULD INTERFERE WITH THE PROPER EXECUTION OF WORK UNLESS NOTED OTHERWISE

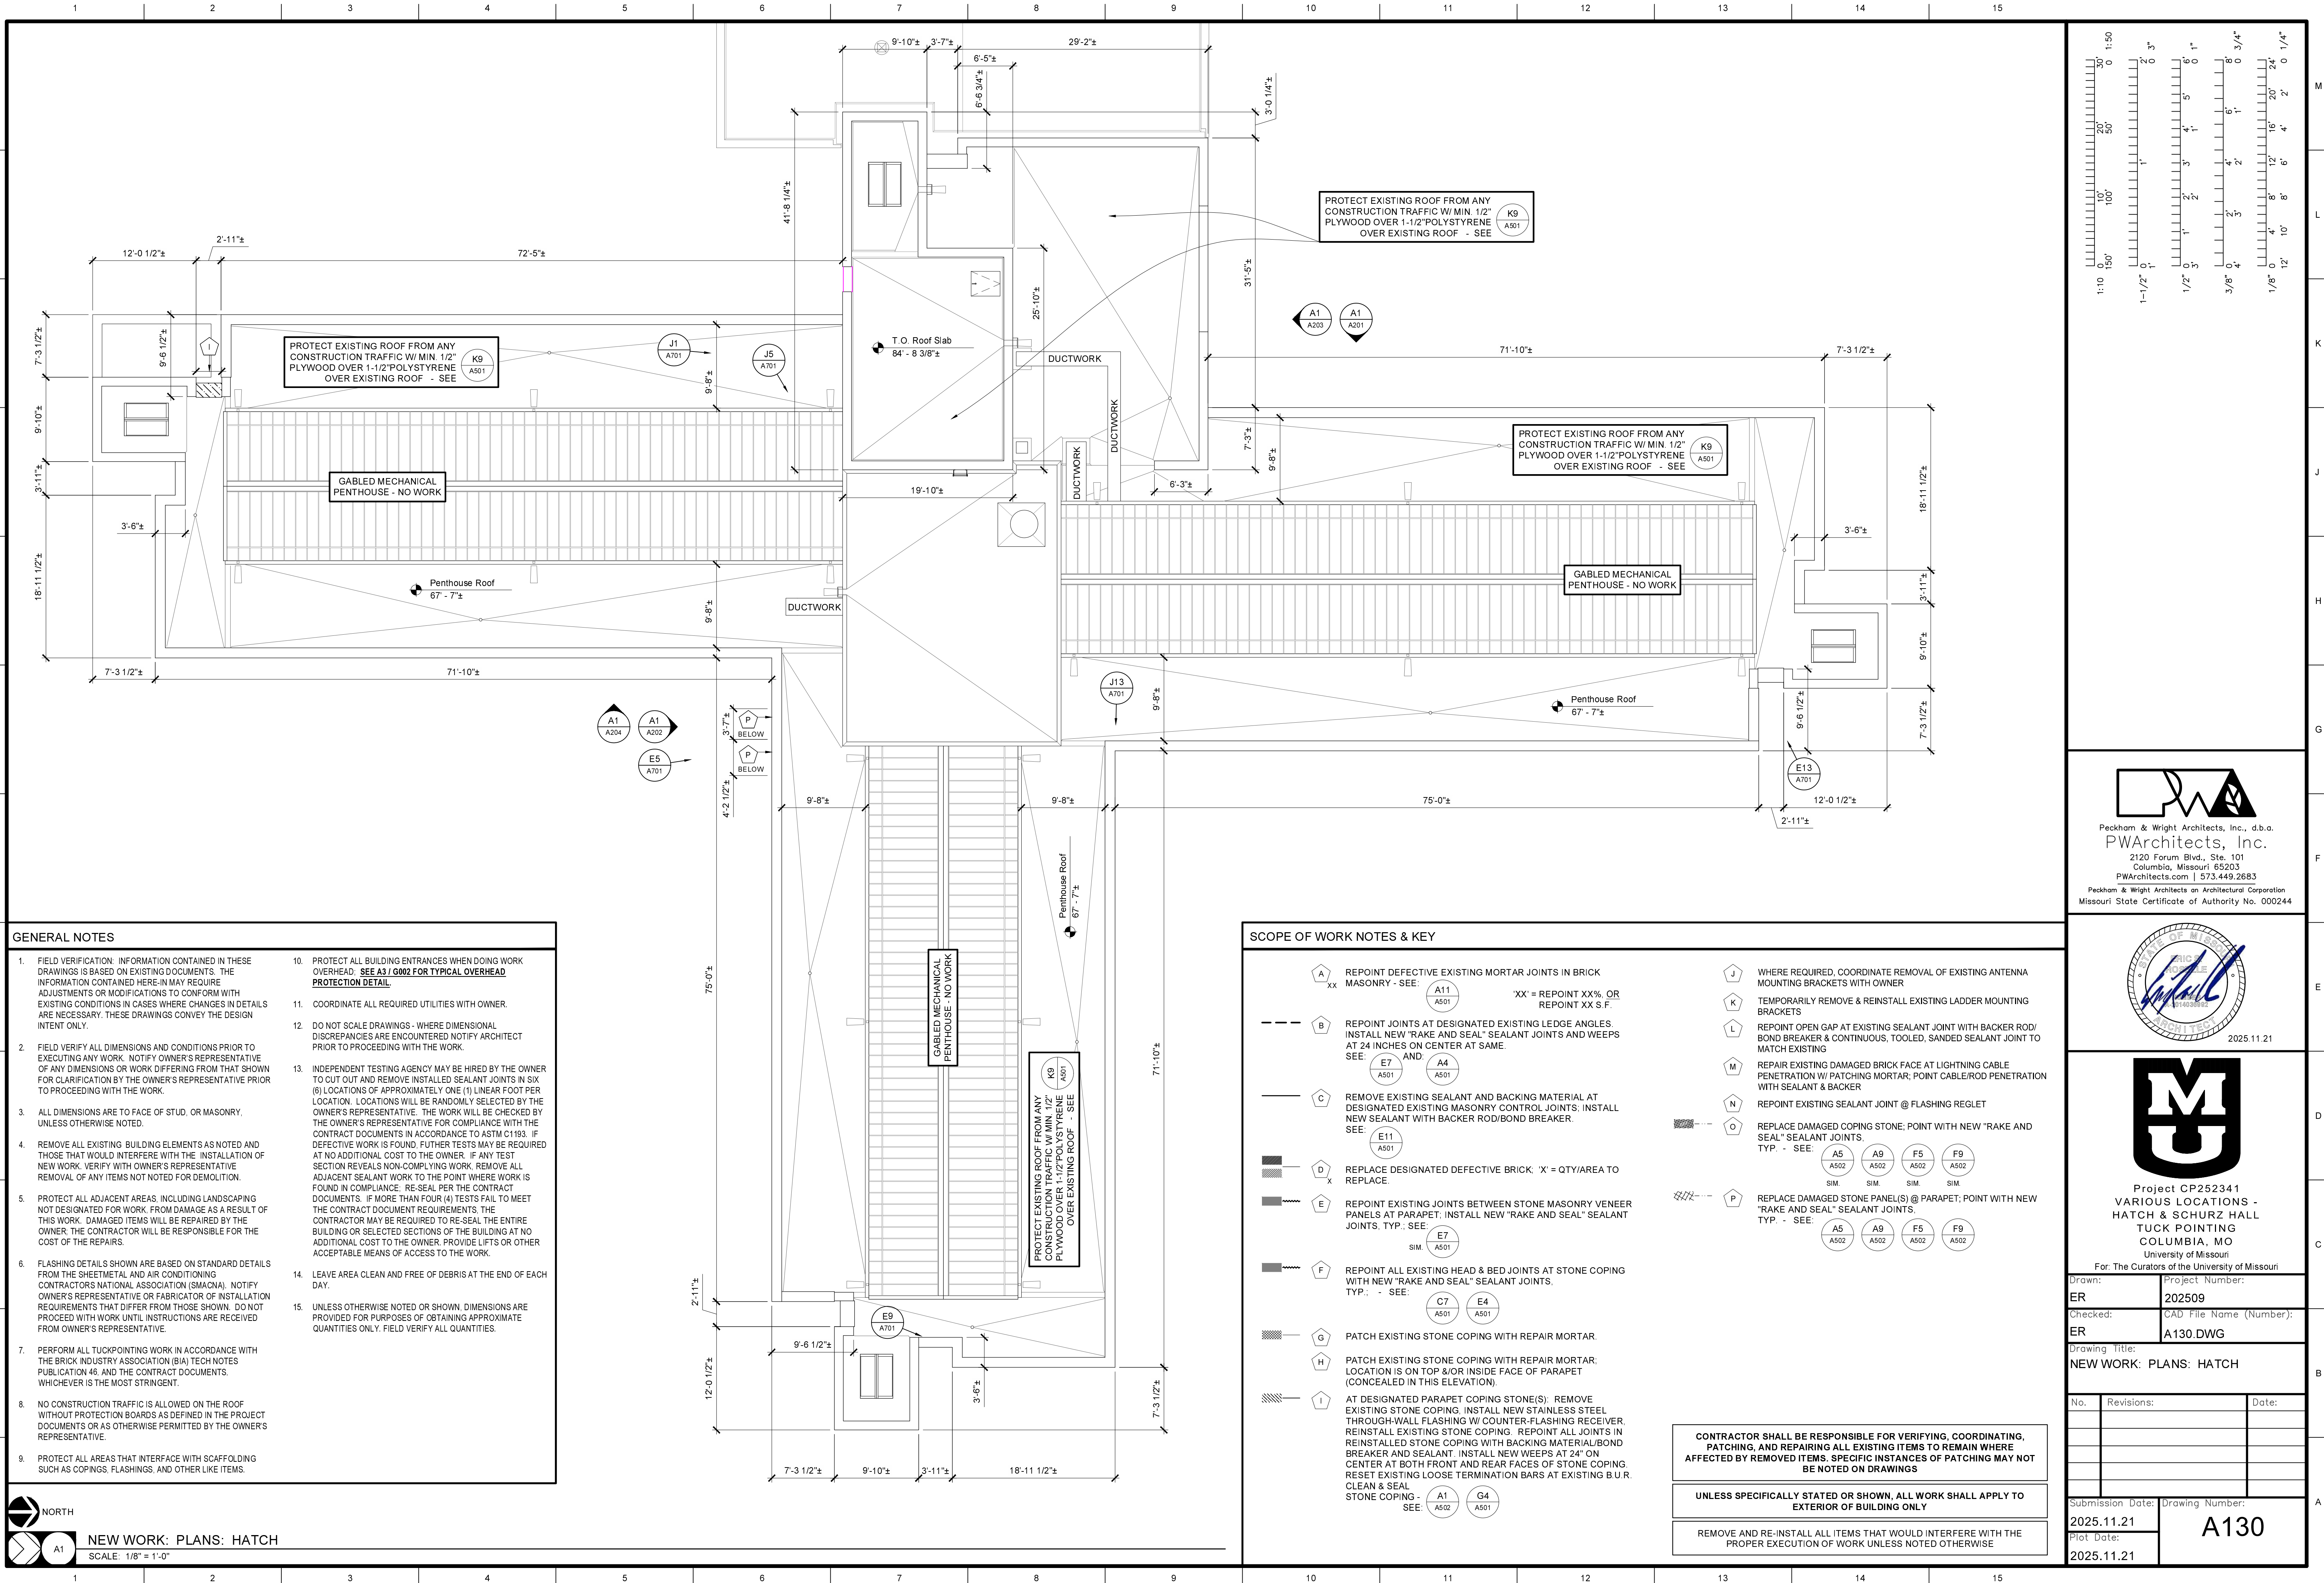1:10 0 10' 20' 30' 0 1:50
1'-1/2" 0 1' 2' 3' 4' 5' 6' 7' 8' 9' 10' 11' 12' 13' 14' 15' 16' 17' 18' 19' 20' 21' 22' 23' 24' 25' 26' 27' 28' 29' 30' 0 1/4"

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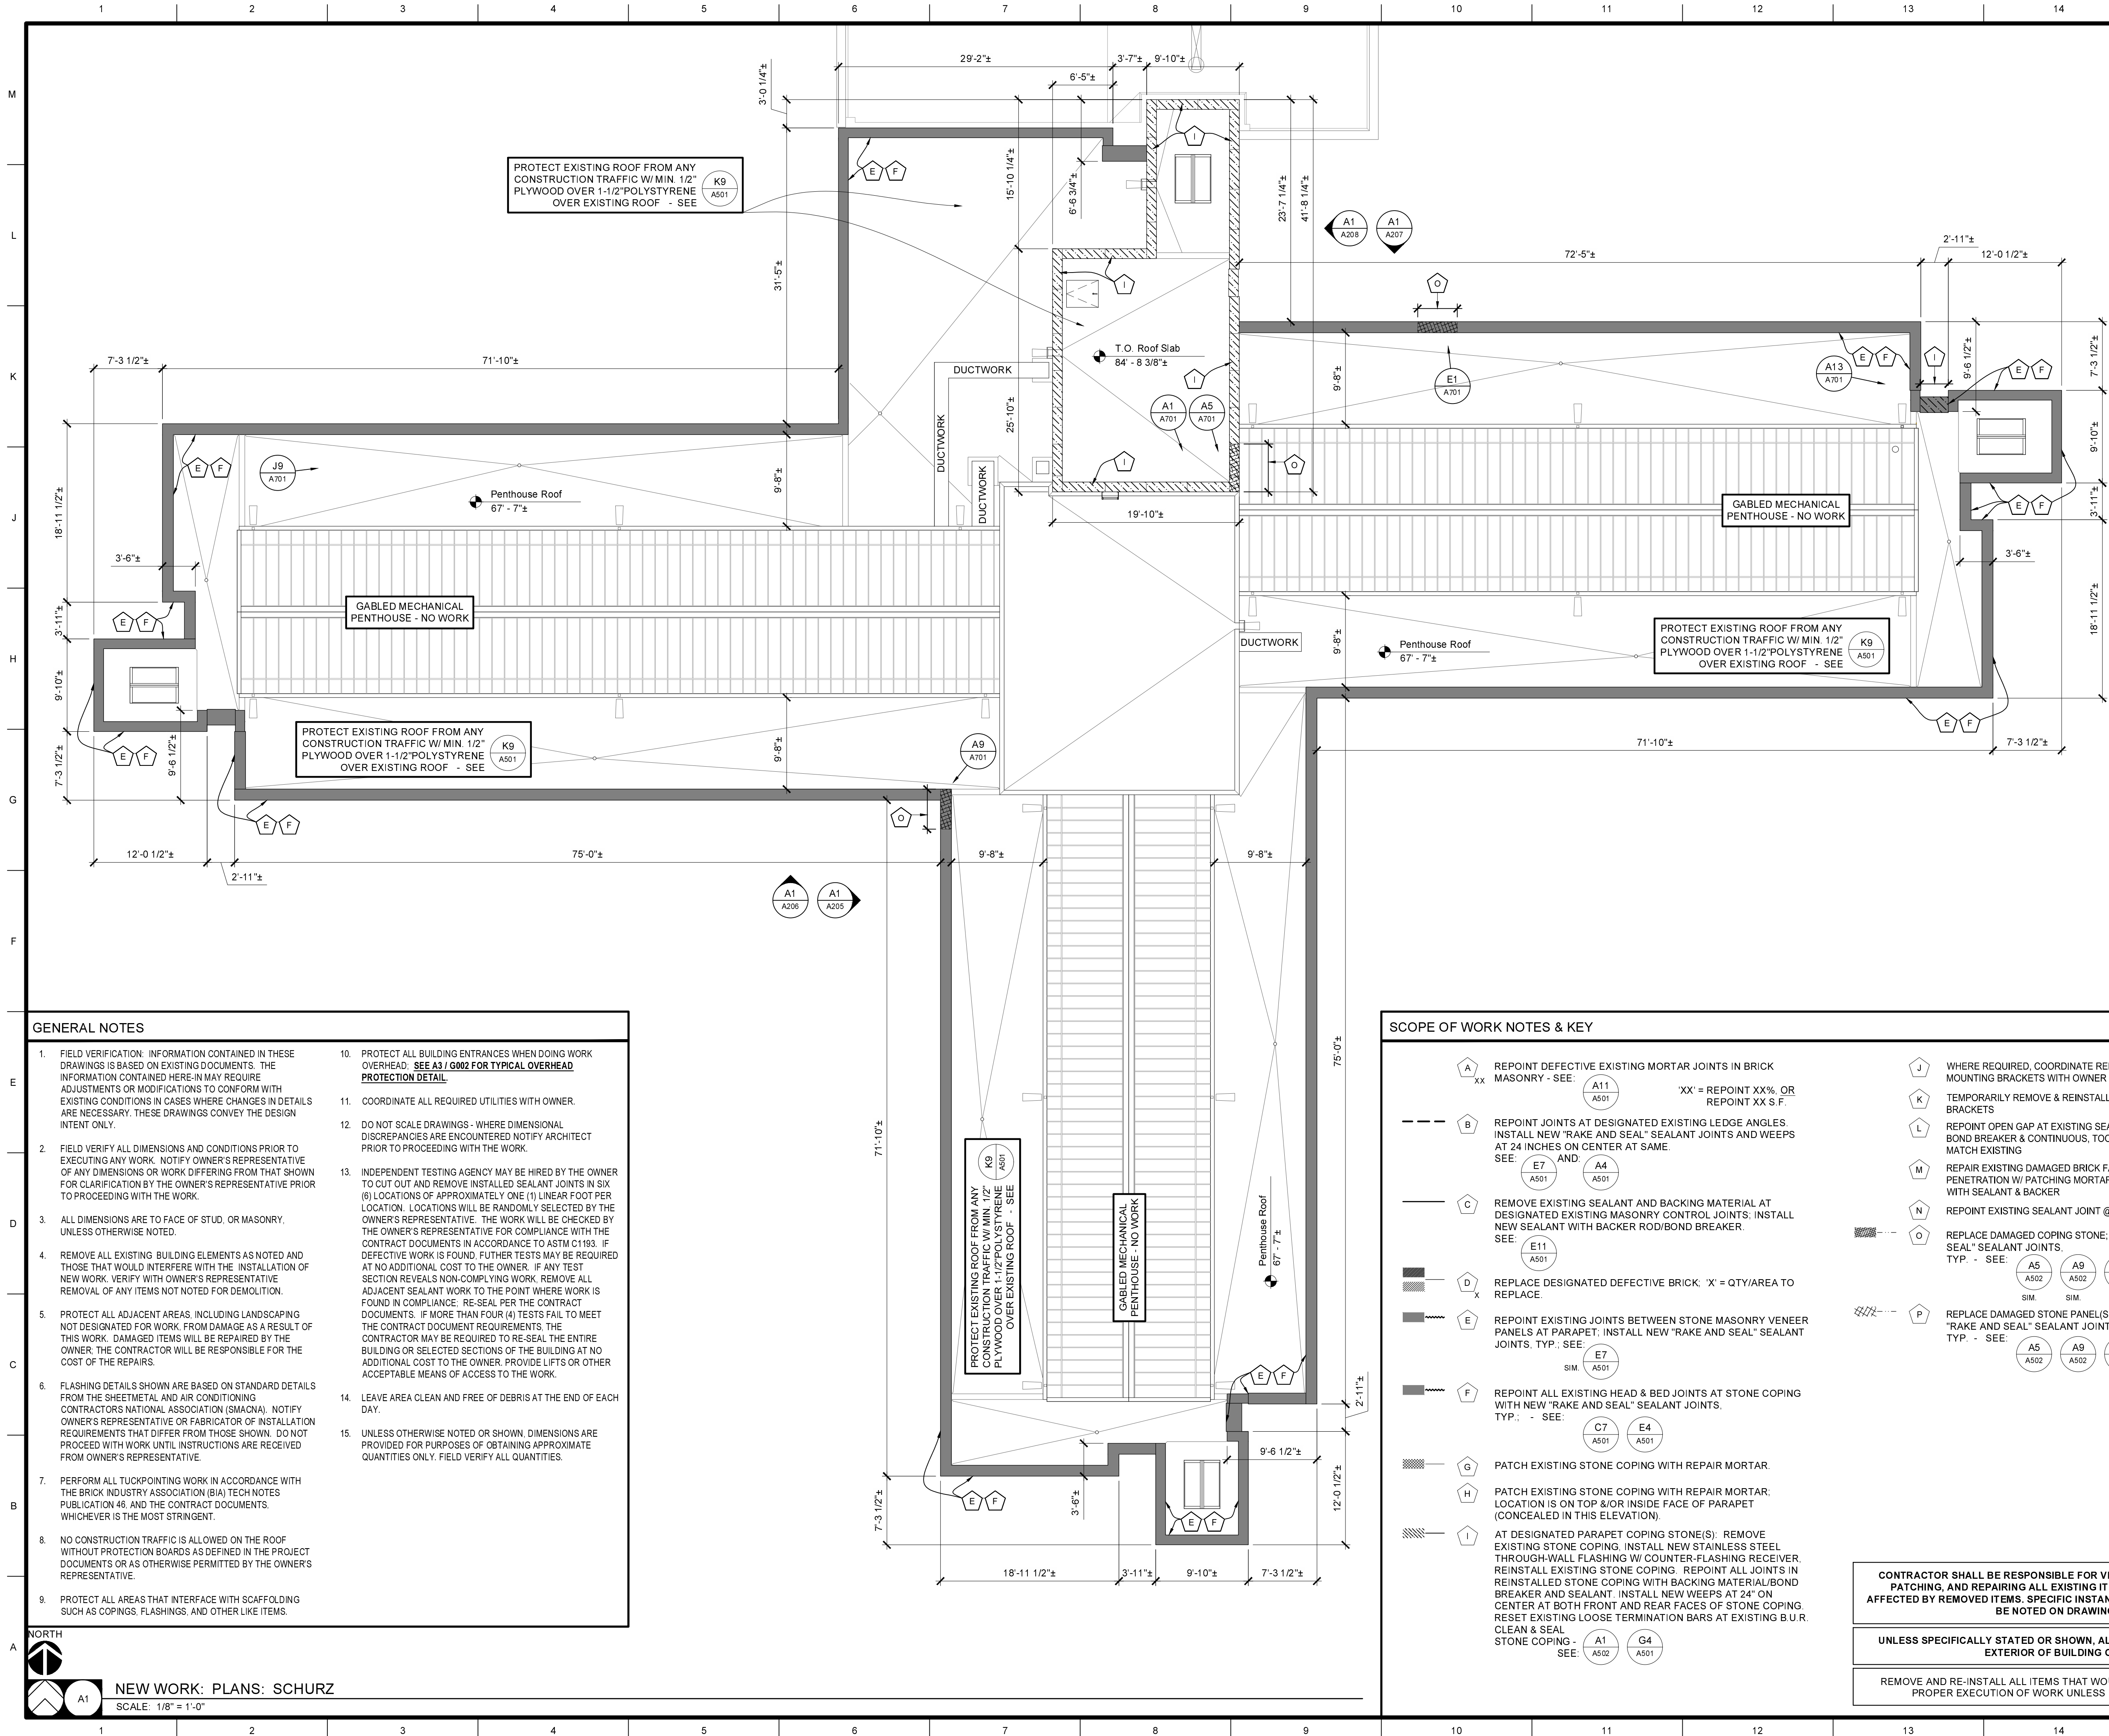
2025.11.21

Project CP252341
VARIOUS LOCATIONS -
HATCH & SCHURZ HALL
TUCK POINTING
COLUMBIA, MO
For: The Curators of the University of Missouri

Drawn: **ER** Project Number: **202509**
Checked: CAD File Name (Number):
ER **A130.DWG**
Drawing Title:
NEW WORK: PLANS: HATCH

No. Revisions: Date:

Submission Date: **2025.11.21** Drawing Number: **A130**
Plot Date: **2025.11.21**





GENERAL NOTES

- FIELD VERIFICATION: INFORMATION CONTAINED IN THESE DRAWINGS IS BASED ON EXISTING DOCUMENTS. THE INFORMATION CONTAINED HERE-IN MAY REQUIRE ADJUSTMENTS OR MODIFICATIONS TO CONFORM WITH EXISTING CONDITIONS IN CASES WHERE CHANGES IN DETAILS ARE NECESSARY. THESE DRAWINGS CONVEY THE DESIGN INTENT ONLY.
- FIELD VERIFY ALL DIMENSIONS AND CONDITIONS PRIOR TO EXECUTING ANY WORK. NOTIFY OWNER'S REPRESENTATIVE OF ANY DIMENSIONS OR WORK DIFFERING FROM THAT SHOWN FOR CLARIFICATION BY THE OWNER'S REPRESENTATIVE PRIOR TO PROCEEDING WITH THE WORK.
- ALL DIMENSIONS ARE TO FACE OF STUD, OR MASONRY, UNLESS OTHERWISE NOTED.
- REMOVE ALL EXISTING BUILDING ELEMENTS AS NOTED AND THOSE THAT WOULD INTERFERE WITH THE INSTALLATION OF NEW WORK. VERIFY WITH OWNER'S REPRESENTATIVE. REMOVAL OF ANY ITEMS NOT NOTED FOR DEMOLITION.
- PROTECT ALL ADJACENT AREAS, INCLUDING LANDSCAPING NOT DESIGNATED FOR WORK. FROM DAMAGE AS A RESULT OF THIS WORK. DAMAGED ITEMS WILL BE REPAIRED BY THE OWNER. THE CONTRACTOR WILL BE RESPONSIBLE FOR THE COST OF THE REPAIRS.
- FLASHING DETAILS SHOWN ARE BASED ON STANDARD DETAILS FROM THE SHEETMETAL AND AIR CONDITIONING CONTRACTORS NATIONAL ASSOCIATION (SMACNA). NOTIFY OWNER'S REPRESENTATIVE OR FABRICATOR OF INSTALLATION REQUIREMENTS THAT DIFFER FROM THOSE SHOWN. DO NOT PROCEED WITH WORK UNTIL INSTRUCTIONS ARE RECEIVED FROM OWNER'S REPRESENTATIVE.
- PERFORM ALL TUCKPOINTING WORK IN ACCORDANCE WITH THE BRICK INDUSTRY ASSOCIATION (BIA) TECH NOTES PUBLICATION 48 AND THE CONTRACT DOCUMENTS, WHICHEVER IS THE MOST STRINGENT.
- NO CONSTRUCTION TRAFFIC IS ALLOWED ON THE ROOF WITHOUT PROTECTION BOARDS AS DEFINED IN THE PROJECT DOCUMENTS OR AS OTHERWISE PERMITTED BY THE OWNER'S REPRESENTATIVE.
- PROTECT ALL AREAS THAT INTERFACE WITH SCAFFOLDING SUCH AS COPINGS, FLASHINGS, AND OTHER LIKE ITEMS.
- PROTECT ALL BUILDING ENTRANCES WHEN DOING WORK OVERHEAD. SEE A3 / G002 FOR TYPICAL OVERHEAD PROTECTION DETAIL.
- COORDINATE ALL REQUIRED UTILITIES WITH OWNER.
- DO NOT SCALE DRAWINGS - WHERE DIMENSIONAL DISCREPANCIES ARE ENCOUNTERED NOTIFY ARCHITECT PRIOR TO PROCEEDING WITH THE WORK.
- INDEPENDENT TESTING AGENCY MAY BE HIRED BY THE OWNER TO CUT OUT AND REMOVE INSTALLED SEALANT JOINTS IN SIX (6) LOCATIONS OF APPROXIMATELY ONE (1) LINEAR FOOT PER LOCATION. LOCATIONS WILL BE RANDOMLY SELECTED BY THE OWNER'S REPRESENTATIVE. THE WORK WILL BE CHECKED BY THE OWNER'S REPRESENTATIVE FOR COMPLIANCE WITH THE CONTRACT DOCUMENTS IN ACCORDANCE TO ASTM C1193. IF DEFECTIVE WORK IS FOUND, FURTHER TESTS MAY BE REQUIRED AT NO ADDITIONAL COST TO THE OWNER. IF ANY TEST SECTION REVEALS NON-COMPLYING WORK, REMOVE ALL ADJACENT SEALANT WORK TO THE POINT WHERE WORK IS FOUND IN COMPLIANCE. RE-SEAL PER THE CONTRACT DOCUMENTS. IF MORE THAN FOUR (4) TESTS FAIL TO MEET THE CONTRACT DOCUMENT REQUIREMENTS, THE CONTRACTOR MAY BE REQUIRED TO RE-SEAL THE ENTIRE BUILDING OR SELECTED SECTIONS OF THE BUILDING AT NO ADDITIONAL COST TO THE OWNER. PROVIDE LIFTS OR OTHER ACCEPTABLE MEANS OF ACCESS TO THE WORK.
- LEAVE AREA CLEAN AND FREE OF DEBRIS AT THE END OF EACH DAY.
- UNLESS OTHERWISE NOTED OR SHOWN, DIMENSIONS ARE PROVIDED FOR PURPOSES OF OBTAINING APPROXIMATE QUANTITIES ONLY. FIELD VERIFY ALL QUANTITIES.

SCOPE OF WORK NOTES & KEY

- REPOINT DEFECTIVE EXISTING MORTAR JOINTS IN BRICK MASONRY - SEE:** A11 A501 'XX' = REPOINT XX%, OR REPOINT XX S.F.
- REPOINT JOINTS AT DESIGNATED EXISTING LEDGE ANGLES. INSTALL NEW "RAKE AND SEAL" SEALANT JOINTS AND WEEPS AT 24 INCHES ON CENTER AT SAME. SEE:** E7 A501 A4 A501
- REMOVE EXISTING SEALANT AND BACKING MATERIAL AT DESIGNATED EXISTING MASONRY CONTROL JOINTS. INSTALL NEW SEALANT WITH BACKER ROD/BOND BREAKER. SEE:** E11 A501
- REPLACE DESIGNATED DEFECTIVE BRICK. 'X' = QTY/AREA TO REPLACE.** D X
- REPOINT EXISTING JOINTS BETWEEN STONE MASONRY VENEER PANELS AT PARAPET. INSTALL NEW "RAKE AND SEAL" SEALANT JOINTS. TYP.: SEE:** E7 A501
- REPOINT ALL EXISTING HEAD & BED JOINTS AT STONE COPING WITH NEW "RAKE AND SEAL" SEALANT JOINTS. TYP.: - SEE:** C7 A501 E4 A501
- PATCH EXISTING STONE COPING WITH REPAIR MORTAR.** G
- PATCH EXISTING STONE COPING WITH REPAIR MORTAR. LOCATION IS ON TOP &/OR INSIDE FACE OF PARAPET (CONCEALED IN THIS ELEVATION).** H
- AT DESIGNATED PARAPET COPING STONE(S): REMOVE EXISTING STONE COPING. INSTALL NEW STAINLESS STEEL THROUGH-WALL FLASHING W/ COUNTER-FLASHING RECEIVER. REINSTALL EXISTING STONE COPING. REPOINT ALL JOINTS IN REINSTALLED STONE COPING WITH BACKING MATERIAL/BOND BREAKER AND SEALANT. INSTALL NEW WEEPS AT 24" ON CENTER AT BOTH FRONT AND REAR FACES OF STONE COPING. RESET EXISTING LOOSE TERMINATION BARS AT EXISTING B.U.R. CLEAN & SEAL STONE COPING - SEE:** A1 A502 G4 A501
- WHERE REQUIRED, COORDINATE REMOVAL OF EXISTING ANTENNA MOUNTING BRACKETS WITH OWNER.** J
- TEMPORARILY REMOVE & REINSTALL EXISTING LADDER MOUNTING BRACKETS.** K
- REPOINT OPEN GAP AT EXISTING SEALANT JOINT WITH BACKER ROD/ BOND BREAKER & CONTINUOUS, TOOLED, SANDED SEALANT JOINT TO MATCH EXISTING.** L
- REPAIR EXISTING DAMAGED BRICK FACE AT LIGHTNING CABLE PENETRATION W/ PARAPET MORTAR, POINT CABLE/ROD PENETRATION WITH SEALANT & BACKER.** M
- REPOINT EXISTING SEALANT JOINT @ FLASHING REGLET.** N
- REPLACE DAMAGED COPING STONE; POINT WITH NEW "RAKE AND SEAL" SEALANT JOINTS. TYP. - SEE:** A5 A502 A9 A502 F5 A502 F9 A502
- REPLACE DAMAGED STONE PANEL(S) @ PARAPET; POINT WITH NEW "RAKE AND SEAL" SEALANT JOINTS. TYP. - SEE:** A5 A502 A9 A502 F5 A502 F9 A502
- CONTRACTOR SHALL BE RESPONSIBLE FOR VERIFYING, COORDINATING, PATCHING, AND REPAIRING ALL EXISTING ITEMS TO REMAIN WHERE AFFECTED BY REMOVED ITEMS. SPECIFIC INSTANCES OF PATCHING MAY NOT BE NOTED ON DRAWINGS.**
- UNLESS SPECIFICALLY STATED OR SHOWN, ALL WORK SHALL APPLY TO EXTERIOR OF BUILDING ONLY.**
- REMOVE AND RE-INSTALL ALL ITEMS THAT WOULD INTERFERE WITH THE PROPER EXECUTION OF WORK UNLESS NOTED OTHERWISE.**

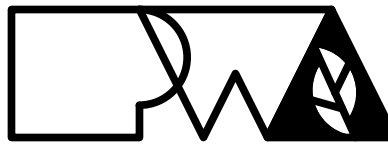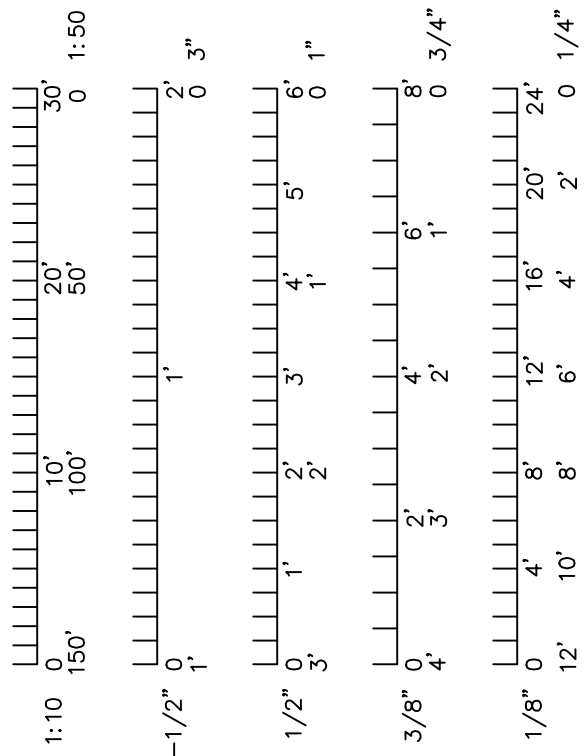

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Missouri State Certificate of Authority No. 000244



Project CP252341
VARIOUS LOCATIONS -
HATCH & SCHURZ HALL
TUCK POINTING
COLUMBIA, MO
For: The Curators of the University of Missouri

Drawn: Project Number:

ER 202509

Checked: CAD File Name (Number):

ER A130.DWG

Drawing Title:

NEW WORK: PLANS: SCHURZ

No. Revisions: Date:

Submission Date: Drawing Number:

2025.11.21 A131

Plot Date: 2025.11.21

	1	2	3	4	5	6	7	8	9	10	11	12	13	14	15
GENERAL NOTES							SCOPE OF WORK NOTES & KEY								
1.	FIELD VERIFICATION: INFORMATION CONTAINED IN THESE DRAWINGS IS BASED ON EXISTING DOCUMENTS. THE INFORMATION CONTAINED HERE-IN MAY REQUIRE ADJUSTMENTS OR MODIFICATIONS TO CONFORM WITH EXISTING CONDITIONS IN CASES WHERE CHANGES IN DETAILS ARE NECESSARY. THESE DRAWINGS CONVEY THE DESIGN INTENT ONLY.			13. INDEPENDENT TESTING AGENCY MAY BE HIRED BY THE OWNER TO CUT OUT AND REMOVE INSTALLED SEALANT JOINTS IN SIX (6) LOCATIONS OF APPROXIMATELY ONE (1) LINEAR FOOT PER LOCATION. LOCATIONS WILL BE RANDOMLY SELECTED BY THE OWNER'S REPRESENTATIVE. THE WORK WILL BE CHECKED BY THE OWNER'S REPRESENTATIVE FOR COMPLIANCE WITH THE CONTRACT DOCUMENTS IN ACCORDANCE TO ASTM C1193. IF DEFECTIVE WORK IS FOUND, FURTHER TESTS MAY BE REQUIRED AT NO ADDITIONAL COST TO THE OWNER. IF ANY TEST SECTION REVEALS NON-COMPLYING WORK, REMOVE ALL ADJACENT SEALANT WORK TO THE POINT WHERE WORK IS FOUND IN COMPLIANCE; RE-SEAL PER THE CONTRACT DOCUMENTS. IF MORE THAN FOUR (4) TESTS FAIL TO MEET THE CONTRACT DOCUMENT REQUIREMENTS, THE CONTRACTOR MAY BE REQUIRED TO RE-SEAL THE ENTIRE BUILDING OR SELECTED SECTIONS OF THE BUILDING AT NO ADDITIONAL COST TO THE OWNER. PROVIDE LIFTS OR OTHER ACCEPTABLE MEANS OF ACCESS TO THE WORK.											
2.	FIELD VERIFY ALL DIMENSIONS AND CONDITIONS PRIOR TO EXECUTING ANY WORK. NOTIFY OWNER'S REPRESENTATIVE OF ANY DIMENSIONS OR WORK DIFFERING FROM THAT SHOWN FOR CLARIFICATION BY THE OWNER'S REPRESENTATIVE PRIOR TO PROCEEDING WITH THE WORK.			14. LEAVE AREA CLEAN AND FREE OF DEBRIS AT THE END OF EACH DAY.											
3.	ALL DIMENSIONS ARE TO FACE OF STUD, OR MASONRY, UNLESS OTHERWISE NOTED.			15. UNLESS OTHERWISE NOTED OR SHOWN, DIMENSIONS ARE PROVIDED FOR PURPOSES OF OBTAINING APPROXIMATE QUANTITIES ONLY. FIELD VERIFY ALL QUANTITIES.											
4.	REMOVE ALL EXISTING BUILDING ELEMENTS AS NOTED AND THOSE THAT WOULD INTERFERE WITH THE INSTALLATION OF NEW WORK. VERIFY WITH OWNER'S REPRESENTATIVE REMOVAL OF ANY ITEMS NOT NOTED FOR DEMOLITION.														
5.	PROTECT ALL ADJACENT AREAS, INCLUDING LANDSCAPING NOT DESIGNATED FOR WORK, FROM DAMAGE AS A RESULT OF THIS WORK. DAMAGED ITEMS WILL BE REPAIRED BY THE OWNER. THE CONTRACTOR WILL BE RESPONSIBLE FOR THE COST OF THE REPAIRS.														
6.	FLASHING DETAILS SHOWN ARE BASED ON STANDARD DETAILS FROM THE SHEETMETAL AND AIR CONDITIONING CONTRACTORS NATIONAL ASSOCIATION (SMACNA). NOTIFY OWNER'S REPRESENTATIVE OR FABRICATOR OF INSTALLATION REQUIREMENTS THAT DIFFER FROM THOSE SHOWN. DO NOT PROCEED WITH WORK UNTIL INSTRUCTIONS ARE RECEIVED FROM OWNER'S REPRESENTATIVE.														
7.	PERFORM ALL TUCKPOINTING WORK IN ACCORDANCE WITH THE BRICK INDUSTRY ASSOCIATION (BIA) TECH NOTES PUBLICATION 46, AND THE CONTRACT DOCUMENTS, WHICHEVER IS THE MOST STRINGENT.														
8.	NO CONSTRUCTION TRAFFIC IS ALLOWED ON THE ROOF WITHOUT PROTECTION BOARDS AS DEFINED IN THE PROJECT DOCUMENTS OR AS OTHERWISE PERMITTED BY THE OWNER'S REPRESENTATIVE.														
9.	PROTECT ALL AREAS THAT INTERFACE WITH SCAFFOLDING SUCH AS COPINGS, FLASHINGS, AND OTHER LIKE ITEMS.														
10.	PROTECT ALL BUILDING ENTRANCES WHEN DOING WORK OVERHEAD. <u>SEE A3 / G002 FOR TYPICAL OVERHEAD PROTECTION DETAIL.</u>														
11.	COORDINATE ALL REQUIRED UTILITIES WITH OWNER.														
12.	DO NOT SCALE DRAWINGS - WHERE DIMENSIONAL DISCREPANCIES ARE ENCOUNTERED NOTIFY ARCHITECT PRIOR TO PROCEEDING WITH THE WORK.														

[illegible]

Figure 1 consists of eight horizontal number lines, labeled 1 through 8, illustrating the construction of the rational number $\frac{1}{2}$. Each line represents a sequence of intervals and their midpoints. The lines are labeled with their respective intervals and midpoints as follows:


- Line 1: Interval $[0, 1]$ with midpoint $\frac{1}{2}$.
- Line 2: Interval $[0, 1]$ with midpoint $\frac{1}{4}$.
- Line 3: Interval $[0, 1]$ with midpoint $\frac{1}{8}$.
- Line 4: Interval $[0, 1]$ with midpoint $\frac{1}{16}$.
- Line 5: Interval $[0, 1]$ with midpoint $\frac{1}{32}$.
- Line 6: Interval $[0, 1]$ with midpoint $\frac{1}{64}$.
- Line 7: Interval $[0, 1]$ with midpoint $\frac{1}{128}$.
- Line 8: Interval $[0, 1]$ with midpoint $\frac{1}{256}$.



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<p>Project CP252341 VARIOUS LOCATIONS - HATCH & SCHURZ HALL TUCK POINTING COLUMBIA, MO University of Missouri For: The Curators of the University of Missouri</p>		
Drawn:	Project Number:	
ER, DP	202509	
Checked:	CAD File Name (Number):	
ER	A201.DWG	
Drawing Title:		
NEW WORK: ELEVATIONS: HATCH		
No.	Revisions:	Date:
Submission Date:		Drawing Number:
2025.11.21		A203
Plot Date:		
2025.11.21		

1

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GENERAL NOTES

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SCOPE OF WORK NOTES & KEY

A

xx

REPOINT DEFECTIVE EXISTING MORTAR JOINTS IN BRICK MASONRY - SEE:

A11

A501

 'XX' = REPOINT XX%, OR REPOINT XX S.F.

B

REPOINT JOINTS AT DESIGNATED EXISTING LEDGE ANGLES. INSTALL NEW "RAKE AND SEAL" SEALANT JOINTS AND WEEPS AT 24 INCHES ON CENTER AT SAME. SEE:

E7

A501

 AND

A4

A501

C

REMOVE EXISTING SEALANT AND BACKING MATERIAL AT DESIGNATED EXISTING MASONRY CONTROL JOINTS. INSTALL NEW SEALANT WITH BACKER ROD/BOND BREAKER. SEE:

E11

A501

D

X

REPLACE DESIGNATED DEFECTIVE BRICK; 'X' = QTY/AREA TO REPLACE.

E

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REPOINT EXISTING JOINTS BETWEEN STONE MASONRY VENEER PANELS AT PARAPET. INSTALL NEW "RAKE AND SEAL" SEALANT JOINTS, TYP., SEE: 

E7

A501

 SIM.

F

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REPOINT ALL EXISTING HEAD & BED JOINTS AT STONE COPING WITH NEW "RAKE AND SEAL" SEALANT JOINTS, TYP., - SEE:

C7

A501

 AND

E4

A501

G

PATCH EXISTING STONE COPING WITH REPAIR MORTAR.

H

PATCH EXISTING STONE COPING WITH REPAIR MORTAR. LOCATION IS ON TOP &/OR INSIDE FACE OF PARAPET (CONCEALED IN THIS ELEVATION).

I

AT DESIGNATED PARAPET COPING STONE(S). REMOVE EXISTING STONE COPING. INSTALL NEW STAINLESS STEEL THROUGH-WALL FLASHING W/ COUNTER-FLASHING RECEIVER. REINSTALL EXISTING STONE COPING. REPOINT ALL JOINTS IN REINSTALLED STONE COPING WITH BACKING MATERIAL/BOND BREAKER AND SEALANT. INSTALL NEW WEEPS AT 24" ON CENTER AT BOTH FRONT AND REAR FACES OF STONE COPING. RESET EXISTING LOOSE TERMINATION BARS AT EXISTING B.U.R. CLEAN & SEAL STONE COPING - SEE:

A1

A502

 AND

G4

A501

J

WHERE REQUIRED, COORDINATE REMOVAL OF EXISTING ANTENNA MOUNTING BRACKETS WITH OWNER

K

TEMPORARILY REMOVE & REINSTALL EXISTING LADDER MOUNTING BRACKETS

L

REPOINT OPEN GAP AT EXISTING SEALANT JOINT WITH BACKER ROD/ BOND BREAKER & CONTINUOUS, TOOLED, SANDED SEALANT JOINT TO MATCH EXISTING

M

REPAIR EXISTING DAMAGED BRICK FACE AT LIGHTNING CABLE PENETRATION W/ PATCHING MORTAR; POINT CABLE/ROD PENETRATION WITH SEALANT & BACKER

N

REPOINT EXISTING SEALANT JOINT @ FLASHING REGLET

O

REPLACE DAMAGED COPING STONE; POINT WITH NEW "RAKE AND SEAL" SEALANT JOINTS. TYP. - SEE:

A5

A502

 SIM.

A9

A502

 SIM.

F5

A502

 SIM.

F9

A502

 SIM.

P

REPLACE DAMAGED STONE PANEL(S) @ PARAPET; POINT WITH NEW "RAKE AND SEAL" SEALANT JOINTS. TYP. - SEE:

A5

A502

 SIM.

A9

A502

 SIM.

F5

A502

 SIM.

F9

A502

 SIM.

CONTRACTOR SHALL BE RESPONSIBLE FOR VERIFYING, COORDINATING, PATCHING, AND REPAIRING ALL EXISTING ITEMS TO REMAIN WHERE AFFECTED BY REMOVED ITEMS. SPECIFIC INSTANCES OF PATCHING MAY NOT BE NOTED ON DRAWINGS

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HATCH: EAST ELEVATION

A1

G5

A130

SCALE: 1/8" = 1'-0"

1:10

0

10'

150'

1:20

0

20'

50'

1:40

0

40'

100'

1:80

0

80'

200'

1:160

0

160'

400'

1:10

0

10'

150'

1:20

0

20'

50'

1:40

0

40'

100'

1:80

0

80'

200'

1:160

0

160'

400'

1:10

0

10'

150'

1:20

0

20'

50'

1:40

0

40'

100'

1:80

0

80'

200'

1:160

0

160'

400'

1:10

0

10'

150'

1:20

0

20'

50'

1:40

0

40'

100'

1:80

0

80'

200'

1:160

0

160'

400'

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STATE OF MISSOURI
ARCHITECTS
K9
A501
2025.11.21

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Project CP252341
VARIOUS LOCATIONS -
HATCH & SCHURZ HALL
TUCK POINTING
COLUMBIA, MO
University of Missouri
For: The Curators of the University of Missouri




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Checked: ER
Drawing Title: NEW WORK: ELEVATIONS: HATCH

Project Number: 202509
CAD File Name (Number): A201.DWG


No. Revisions: Date:

Submission Date: 2025.11.21
Plot Date: 2025.11.21

Drawing Number: A204


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 <p>2025.11.21</p>		
 <p>Project CP252341 VARIOUS LOCATIONS - HATCH & SCHURZ HALL TUCK POINTING COLUMBIA, MO University of Missouri For: The Curators of the University of Missouri</p>		
Drawn: ER, DP	Project Number: 202509	
Checked: ER	CAD File Name (Number): A201.DWG	
Drawing Title: NEW WORK: ELEVATIONS: SCHURZ		
No.	Revisions:	Date:
Submission Date:		Drawing Number:
2025.11.21		A205
Plot Date:		
2025.11.21		

	1	2	3	4	5	6	7	8	9	10	11	12	13	14	15
	GENERAL NOTES						SCOPE OF WORK NOTES & KEY								
M	<p>1. FIELD VERIFICATION: INFORMATION CONTAINED IN THESE DRAWINGS IS BASED ON EXISTING DOCUMENTS. THE INFORMATION CONTAINED HERE-IN MAY REQUIRE ADJUSTMENTS OR MODIFICATIONS TO CONFORM WITH EXISTING CONDITIONS IN CASES WHERE CHANGES IN DETAILS ARE NECESSARY. THESE DRAWINGS CONVEY THE DESIGN INTENT ONLY.</p> <p>2. FIELD VERIFY ALL DIMENSIONS AND CONDITIONS PRIOR TO EXECUTING ANY WORK. NOTIFY OWNER'S REPRESENTATIVE OF ANY DIMENSIONS OR WORK DIFFERING FROM THAT SHOWN FOR CLARIFICATION BY THE OWNER'S REPRESENTATIVE PRIOR TO PROCEEDING WITH THE WORK.</p> <p>3. ALL DIMENSIONS ARE TO FACE OF STUD, OR MASONRY, UNLESS OTHERWISE NOTED.</p> <p>4. REMOVE ALL EXISTING BUILDING ELEMENTS AS NOTED AND THOSE THAT WOULD INTERFERE WITH THE INSTALLATION OF NEW WORK. VERIFY WITH OWNER'S REPRESENTATIVE REMOVAL OF ANY ITEMS IF NOT NOTED FOR DEMOLITION.</p> <p>5. PROTECT ALL ADJACENT AREAS, INCLUDING LANDSCAPING NOT DESIGNATED FOR WORK, FROM DAMAGE AS A RESULT OF THIS WORK. DAMAGED ITEMS WILL BE REPAIRED BY THE OWNER. THE CONTRACTOR WILL BE RESPONSIBLE FOR THE COST OF THE REPAIRS.</p> <p>6. FLASHING DETAILS SHOWN ARE BASED ON STANDARD DETAILS FROM THE SHEETMETAL AND AIR CONDITIONING CONTRACTORS NATIONAL ASSOCIATION (SMACNA). NOTIFY OWNER'S REPRESENTATIVE OR FABRICATOR OF INSTALLATION REQUIREMENTS THAT DIFFER FROM THOSE SHOWN. DO NOT PROCEED WITH WORK UNTIL INSTRUCTIONS ARE RECEIVED FROM OWNER'S REPRESENTATIVE.</p> <p>7. PERFORM ALL TUCKPOINTING WORK IN ACCORDANCE WITH THE BRICK INDUSTRY ASSOCIATION (BIA) TECH NOTES PUBLICATION 46, AND THE CONTRACT DOCUMENTS, WHICHEVER IS THE MOST STRINGENT.</p> <p>8. NO CONSTRUCTION TRAFFIC IS ALLOWED ON THE ROOF WITHOUT PROTECTION BOARDS AS DEFINED IN THE PROJECT DOCUMENTS OR AS OTHERWISE PERMITTED BY THE OWNER'S REPRESENTATIVE.</p> <p>9. PROTECT ALL AREAS THAT INTERFACE WITH SCAFFOLDING SUCH AS COPINGS, FLASHINGS, AND OTHER LIKE ITEMS.</p> <p>10. PROTECT ALL BUILDING ENTRANCES WHEN DOING WORK OVERHEAD: <u>SEE A3 / G002 FOR TYPICAL OVERHEAD PROTECTION DETAIL.</u></p> <p>11. COORDINATE ALL REQUIRED UTILITIES WITH OWNER.</p> <p>12. DO NOT SCALE DRAWINGS - WHERE DIMENSIONAL DISCREPANCIES ARE ENCOUNTERED NOTIFY ARCHITECT PRIOR TO PROCEEDING WITH THE WORK.</p>						<p>13. INDEPENDENT TESTING AGENCY MAY BE HIRED BY THE OWNER TO CUT OUT AND REMOVE INSTALLED SEALANT JOINTS IN SIX (6) LOCATIONS OF APPROXIMATELY ONE (1) LINEAR FOOT PER LOCATION. LOCATIONS WILL BE RANDOMLY SELECTED BY THE OWNER'S REPRESENTATIVE. THE WORK WILL BE CHECKED BY THE OWNER'S REPRESENTATIVE FOR COMPLIANCE WITH THE CONTRACT DOCUMENTS IN ACCORDANCE TO ASTM C1193. IF DEFECTIVE WORK IS FOUND, FURTHER TESTS MAY BE REQUIRED AT NO ADDITIONAL COST TO THE OWNER. IF ANY TEST SECTION REVEALS NON-COMPLYING WORK, REMOVE ALL ADJACENT SEALANT WORK TO THE POINT WHERE WORK IS FOUND IN COMPLIANCE, RE-SEAL PER THE CONTRACT DOCUMENTS. IF MORE THAN FOUR (4) TESTS FAIL TO MEET THE CONTRACT DOCUMENT REQUIREMENTS, THE CONTRACTOR MAY BE REQUIRED TO RE-SEAL THE ENTIRE BUILDING OR SELECTED SECTIONS OF THE BUILDING AT NO ADDITIONAL COST TO THE OWNER. PROVIDE LIFTS OR OTHER ACCEPTABLE MEANS OF ACCESS TO THE WORK.</p> <p>LEAVE AREA CLEAN AND FREE OF DEBRIS AT THE END OF EACH DAY.</p> <p>15. UNLESS OTHERWISE NOTED OR SHOWN, DIMENSIONS ARE PROVIDED FOR PURPOSES OF OBTAINING APPROXIMATE QUANTITIES ONLY. FIELD VERIFY ALL QUANTITIES.</p>								
L							<p>A xx A11 A501 XX' = REPOINT XX% OR REPOINT XX S.F.</p> <p>B REPOINT JOINTS AT DESIGNATED EXISTING LEDGE ANGLES. INSTALL NEW "RAKE AND SEAL" SEALANT JOINTS AND WEEPS AT 24 INCHES ON CENTER AT SAME SEE: E7 A501 AND A4 A501</p> <p>C REMOVE EXISTING SEALANT AND BACKING MATERIAL AT DESIGNATED EXISTING MASONRY CONTROL JOINTS. INSTALL NEW SEALANT WITH BACKER ROD/BOND BREAKER. SEE: E11 A501</p> <p>D x REPLACE DESIGNATED DEFECTIVE BRICK: 'X' = QTY/AREA TO REPLACE.</p> <p>E REPOINT EXISTING JOINTS BETWEEN STONE MASONRY VENEER PANELS AT PARAPET. INSTALL NEW "RAKE AND SEAL" SEALANT JOINTS. TYP.: SEE: E7 A501 SIM</p> <p>F REPOINT ALL EXISTING HEAD & BED JOINTS AT STONE COPING WITH NEW "RAKE AND SEAL" SEALANT JOINTS. TYP.: - SEE: C7 A501 E4 A501</p> <p>G PATCH EXISTING STONE COPING WITH REPAIR MORTAR.</p> <p>H PATCH EXISTING STONE COPING WITH REPAIR MORTAR. LOCATION IS ON TOP &/OR INSIDE FACE OF PARAPET (CONCEALED IN THIS ELEVATION).</p> <p>I AT DESIGNATED PARAPET COPING STONE(S); REMOVE EXISTING STONE COPING. INSTALL NEW STAINLESS STEEL THROUGH-WALL FLASHING W/ COUNTER-FLASHING RECEIVER. REINSTALL EXISTING STONE COPING. REPOINT ALL JOINTS IN REINSTALLED STONE COPING WITH BACKING MATERIAL/BOND BREAKER AND SEALANT. INSTALL NEW WEEPS AT 24" ON CENTER AT BOTH FRONT AND REAR FACES OF STONE COPING. RESET EXISTING LOOSE TERMINATION BARS AT EXISTING B.U.R. CLEAN & SEAL STONE COPING - SEE: A1 A502 G4 A501</p> <p>J WHERE REQUIRED, COORDINATE REMOVAL OF EXISTING ANTENNA MOUNTING BRACKETS WITH OWNER</p> <p>K TEMPORARILY REMOVE & REINSTALL EXISTING LADDER MOUNTING BRACKETS</p> <p>L REPOINT OPEN GAP AT EXISTING SEALANT JOINT WITH BACKER ROD/ BOND BREAKER & CONTINUOUS, TOOLED, SANDED SEALANT JOINT TO MATCH EXISTING</p> <p>M REPAIR EXISTING DAMAGED BRICK FACE AT LIGHTNING CABLE PENETRATION W/ PATCHING MORTAR; POINT CABLE/ROD PENETRATION WITH SEALANT & BACKER</p> <p>N REPOINT EXISTING SEALANT JOINT @ FLASHING REGLET</p> <p>O REPLACE DAMAGED COPING STONE; POINT WITH NEW "RAKE AND SEAL" SEALANT JOINTS. TYP. - SEE: A5 A502 A9 A502 F5 A502 F9 A502 SIM SIM SIM SIM</p> <p>P REPLACE DAMAGED STONE PANEL(S) @ PARAPET; POINT WITH NEW "RAKE AND SEAL" SEALANT JOINTS. TYP. - SEE: A5 A502 A9 A502 F5 A502 F9 A502 SIM SIM SIM SIM</p>								
K							<p>CONTRACTOR SHALL BE RESPONSIBLE FOR VERIFYING, COORDINATING, PATCHING, AND REPAIRING ALL EXISTING ITEMS TO REMAIN WHERE AFFECTED BY REMOVED ITEMS. SPECIFIC INSTANCES OF PATCHING MAY NOT BE NOTED ON DRAWINGS</p> <p>UNLESS SPECIFICALLY STATED OR SHOWN, ALL WORK SHALL APPLY TO EXTERIOR OF BUILDING ONLY</p> <p>REMOVE AND RE-INSTALL ALL ITEMS THAT WOULD INTERFERE WITH THE PROPER EXECUTION OF WORK UNLESS NOTED OTHERWISE</p>								
J															

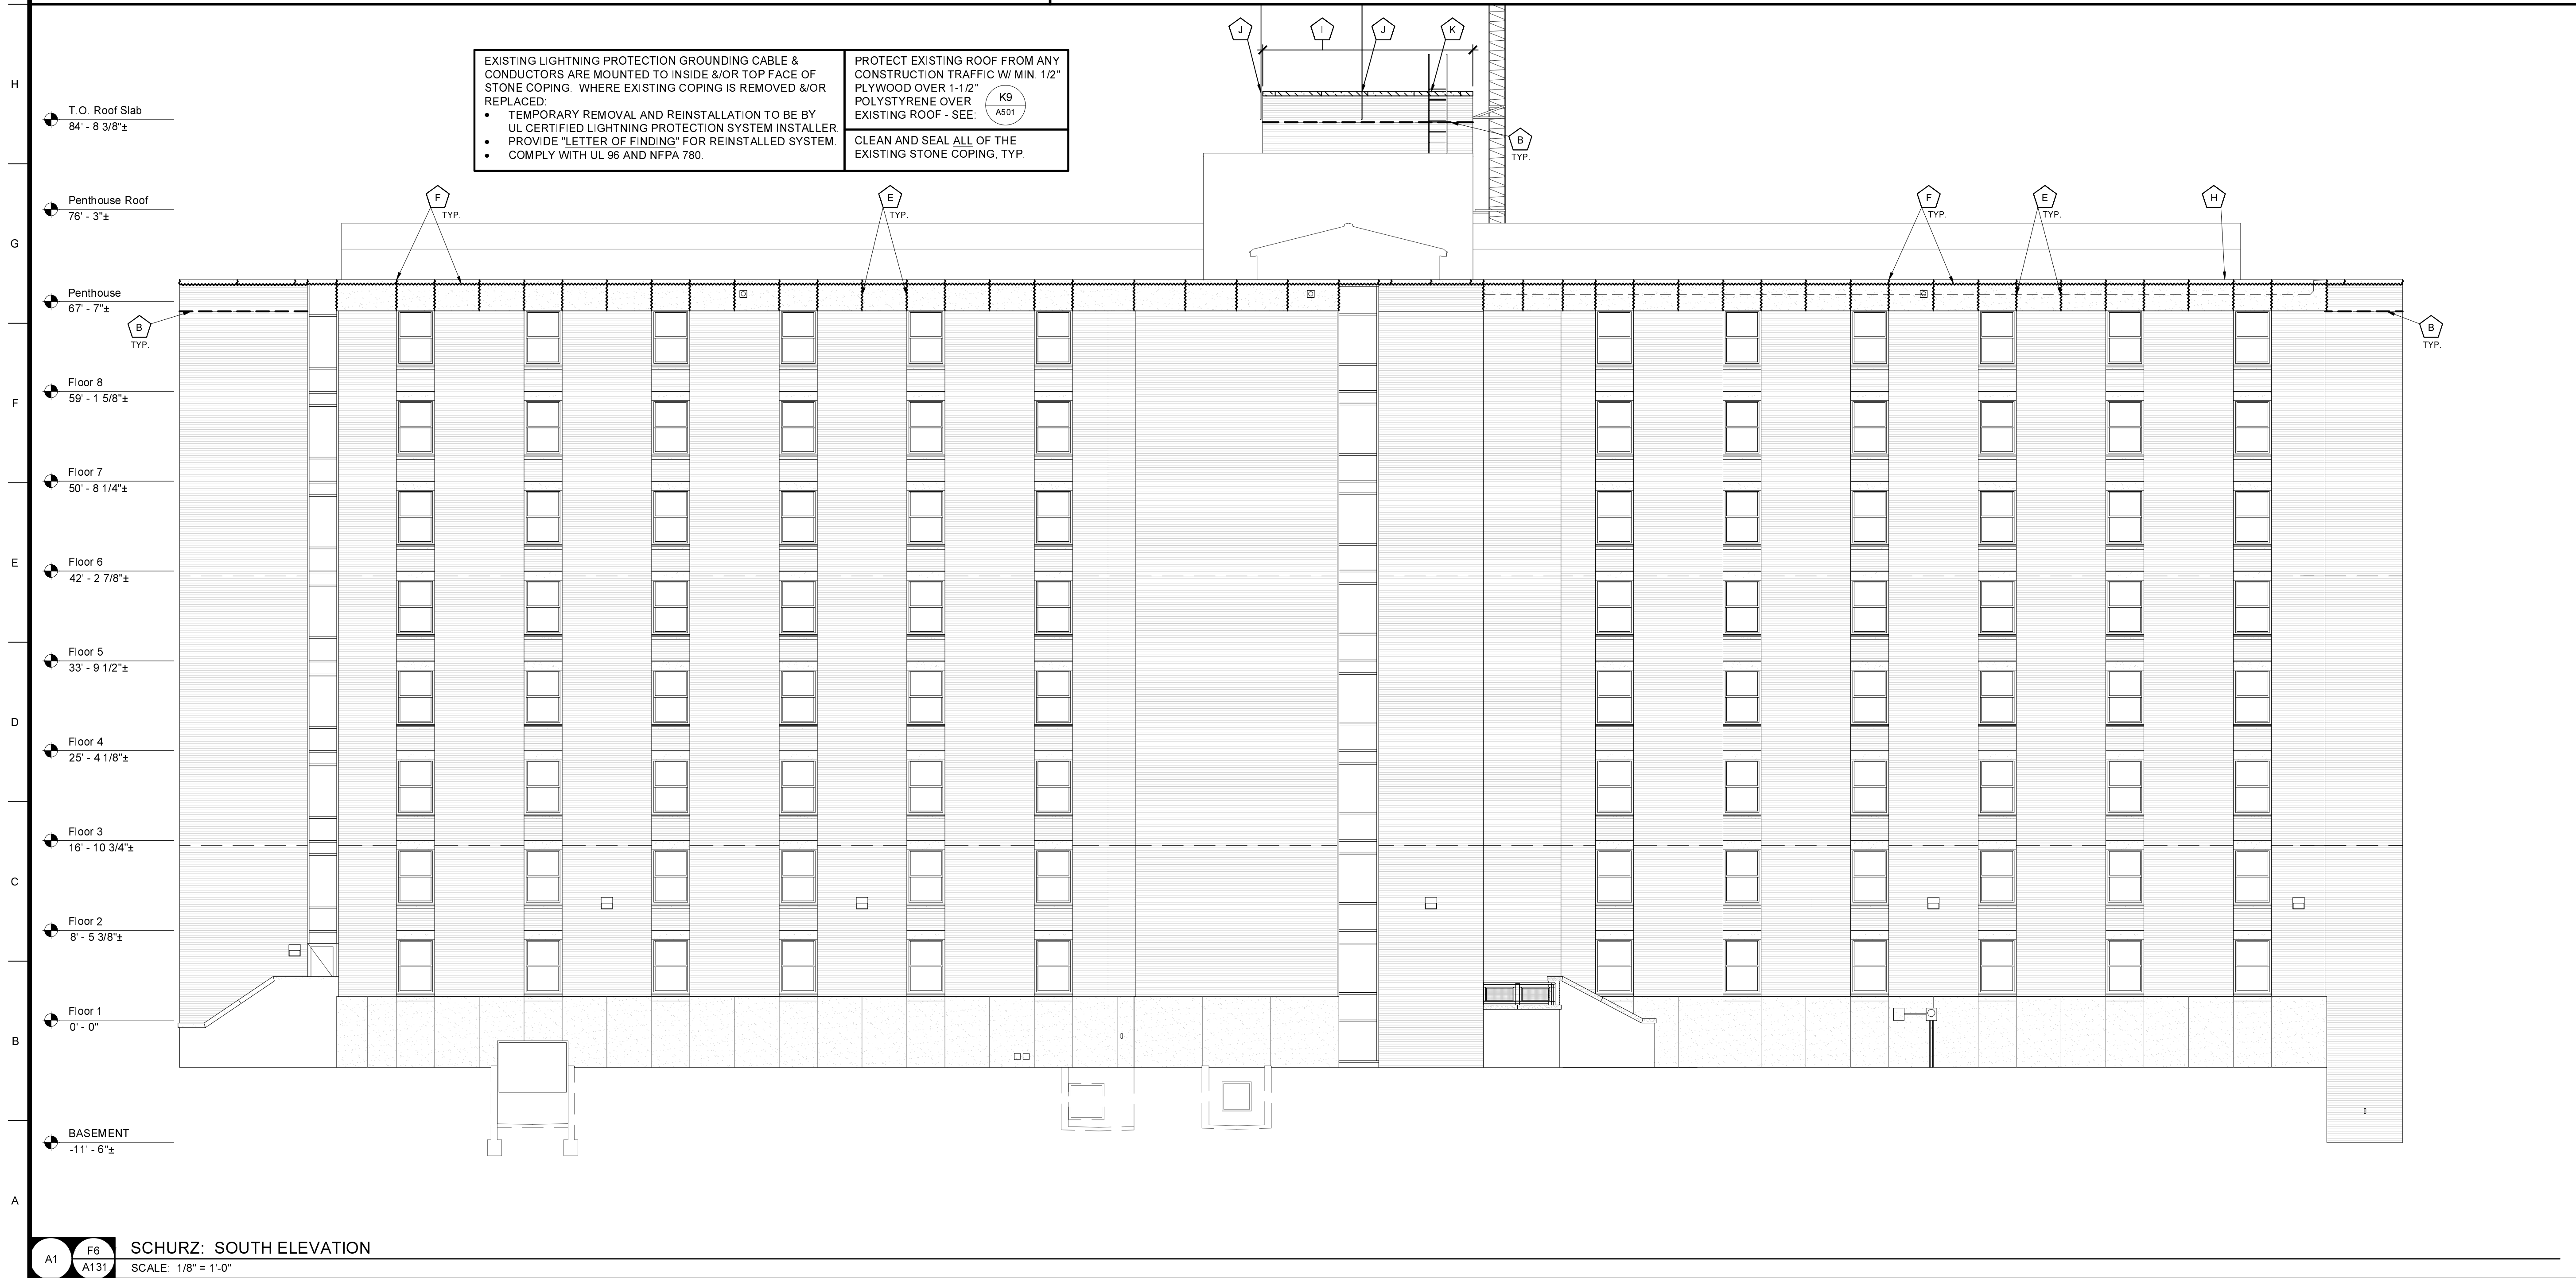

REMOVE AND RE-INSTALL ALL ITEMS THAT WOULD INTERFERE WITH THE
PROPER EXECUTION OF WORK UNLESS NOTED OTHERWISE

<p>EXISTING LIGHTNING PROTECTION GROUNDING CABLE & CONDUCTORS ARE MOUNTED TO INSIDE &/OR TOP FACE OF STONE COPING. WHERE EXISTING COPING IS REMOVED &/OR REPLACED:</p> <ul style="list-style-type: none"> • TEMPORARY REMOVAL AND REINSTALLATION TO BE BY UL CERTIFIED LIGHTNING PROTECTION SYSTEM INSTALLER • PROVIDE "LETTER OF FINDING" FOR REINSTALLED SYSTEM. • COMPLY WITH UL 96 AND NFPA 780. 	<p>PROTECT EXISTING ROOF FROM ANY CONSTRUCTION TRAFFIC W/ MIN. 1/2" PLYWOOD OVER 1-1/2" POLYSTYRENE OVER EXISTING ROOF - SEE:</p>
	<p>CLEAN AND SEAL ALL OF THE EXISTING STONE COPING. TYP.</p>

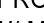PROTECT EXISTING ROOF FROM ANY
CONSTRUCTION TRAFFIC W/ MIN. 1/2"
PLYWOOD OVER 1-1/2" POLYSTYRENE OVER
EXISTING ROOF - SEE: 

CLEAN AND SEAL ALL OF THE
EXISTING STONE COPING, TYP.




Pekham & Wright Architects, Inc., d.b.a.
PWArchitects, Inc.
 2120 Forum Blvd., Ste. 101
 Columbia, Missouri 65203
 PWArchitects.com | 573.449.2683

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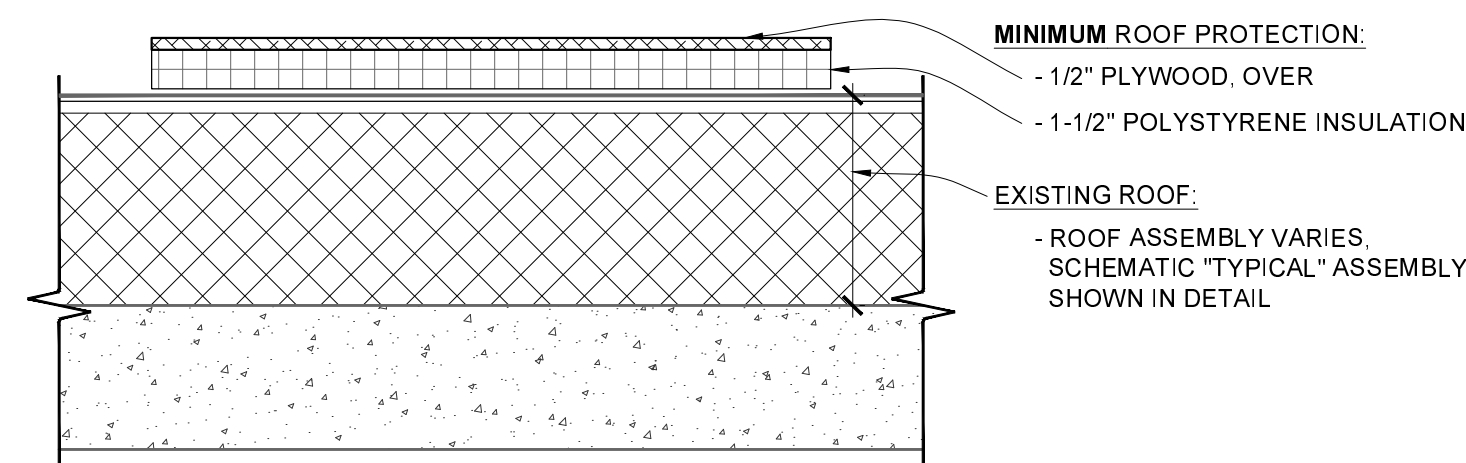


Project CP252341
VARIOUS LOCATIONS -
HATCH & SCHURZ HALL
TUCK POINTING
COLUMBIA, MO
University of Missouri
For: The Curators of the University of Missouri

Drawn:		Project Number:	
ER, DP		202509	
Checked:		CAD File Name (Number):	
ER		A201.DWG	
Drawing title:			
NEW WORK: ELEVATIONS: SCHURZ			
No.	Revisions:	Date:	
Submission Date:		Drawing Number:	
2025.11.21		A208	
Plot Date:			
2025.11.21			

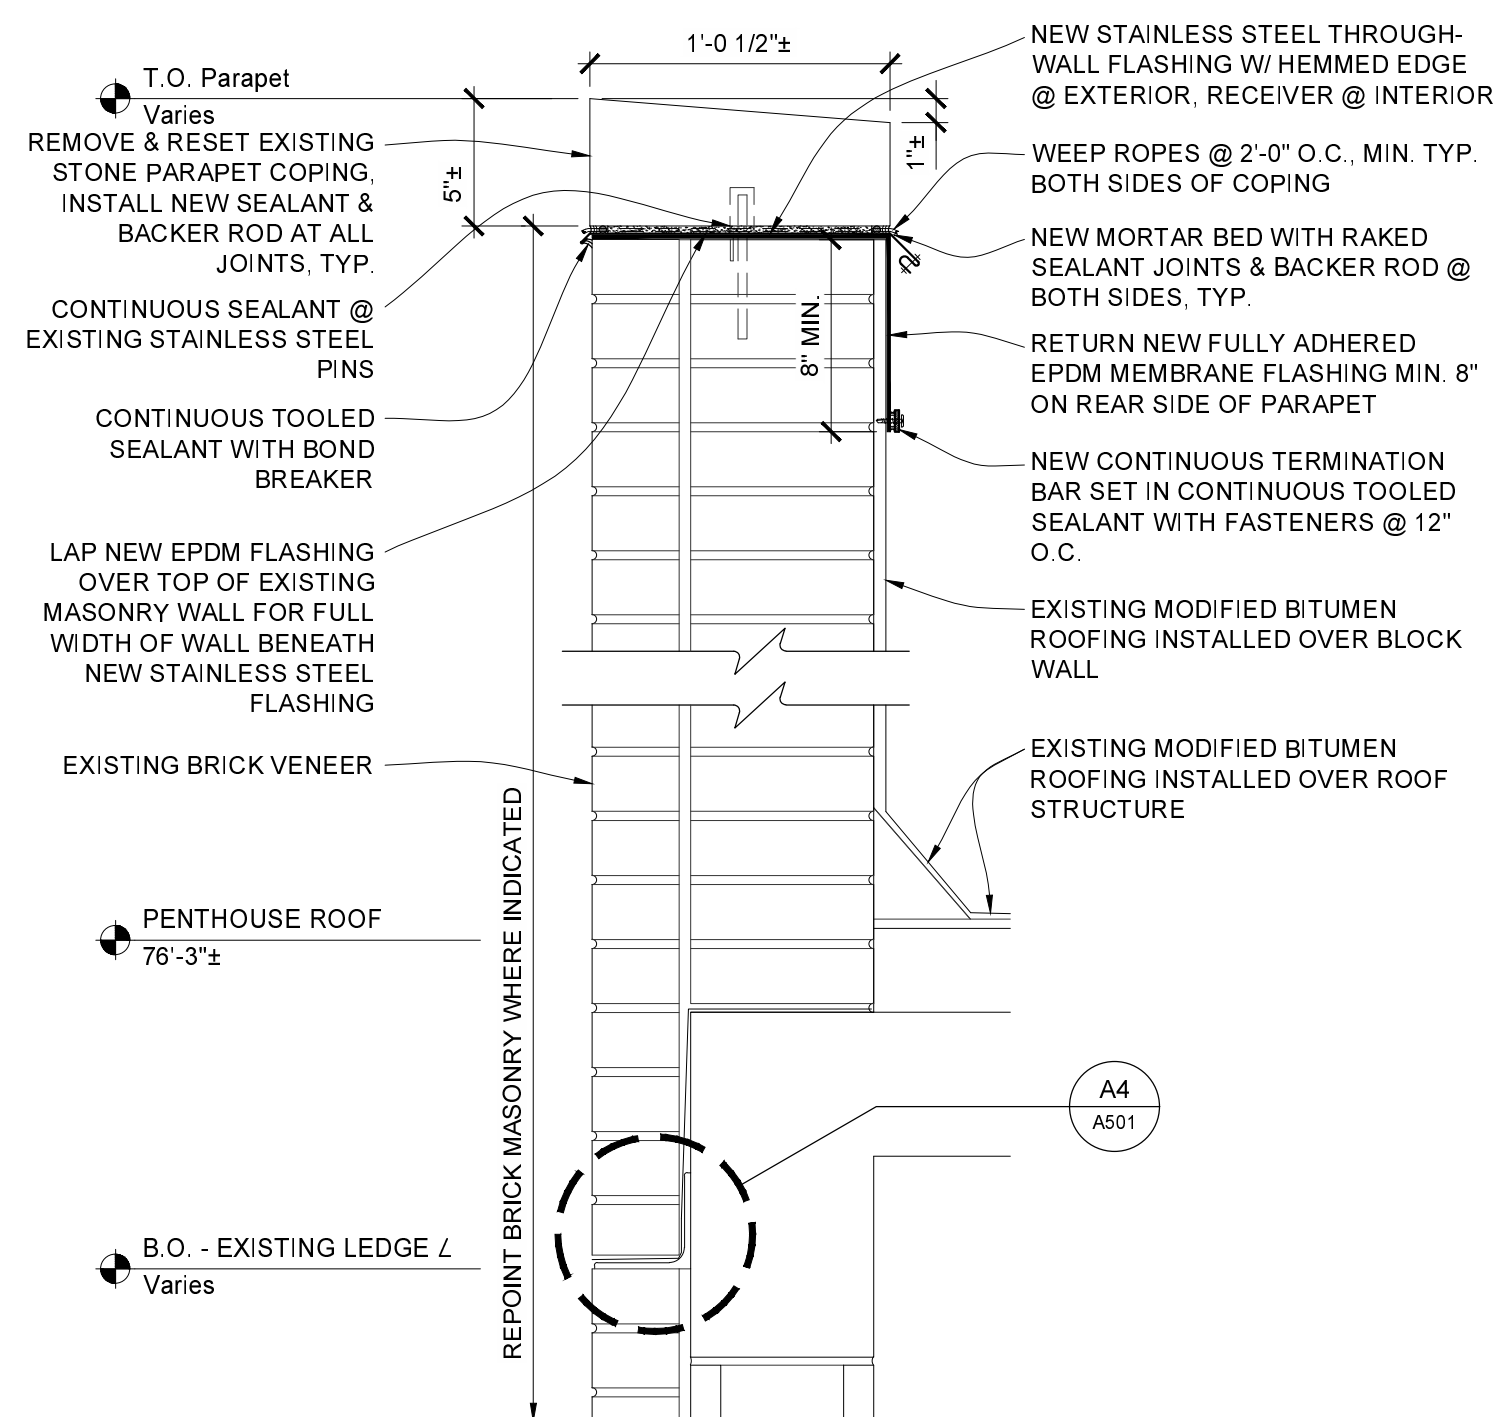

TYP. PARAPET DETAIL @ STONE COPING @ PENTHOUSE
SCALE: 1-1/2" = 1'-0"




THE OWNER HAS EXISTING ROOF WARRANTIES IN EFFECT:

- ANY ROOF DAMAGE CAUSED BY CONSTRUCTION OPERATIONS MUST BE REPAIRED USING A LICENSED ROOFING CONTRACTOR FOR THAT SYSTEM.
- ALL SUCH DAMAGE REPAIR MUST BE PERFORMED IN A MANNER THAT MAINTAINS THE WARRANTY.
- ALL SUCH DAMAGE REPAIR MUST BE PERFORMED TO THE SATISFACTION OF THE OWNER'S REPRESENTATIVE.
- ALL SUCH DAMAGE REPAIR MUST BE PERFORMED AT NO COST TO THE OWNER.


**PREPARE AND SUBMIT A WRITTEN ROOF PROTECTION PLAN & DRAWINGS TO OWNER AND ARCHITECT
PRIOR TO BEGINNING ANY WORK AT ROOF LEVEL**

TYP. ROOF PROTECTION DETAIL
SCALE: 1-1/2" = 1'-0"

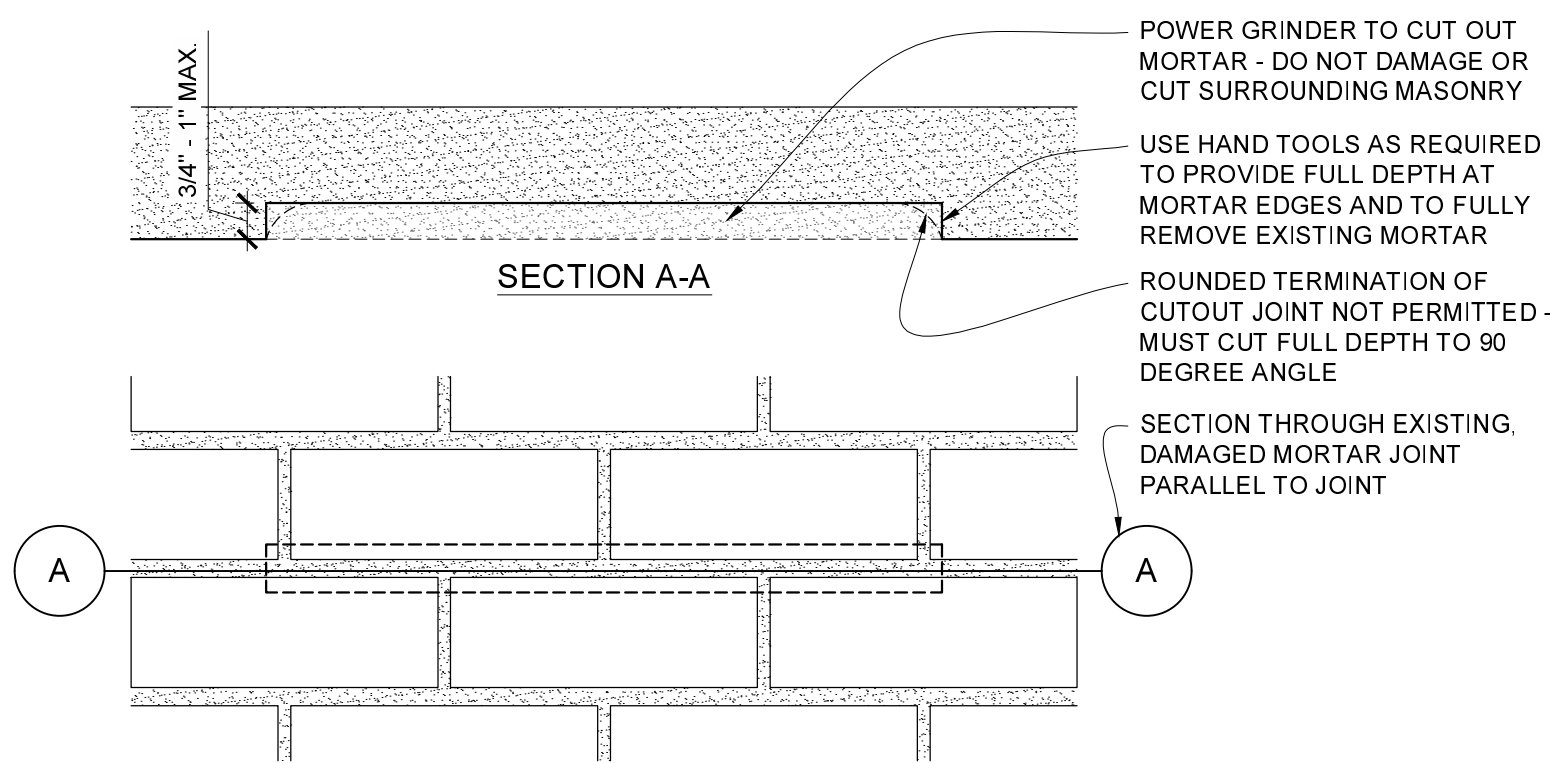


TYPICAL REPOINTING DETAIL


SCALE: 3" = 1'-0"

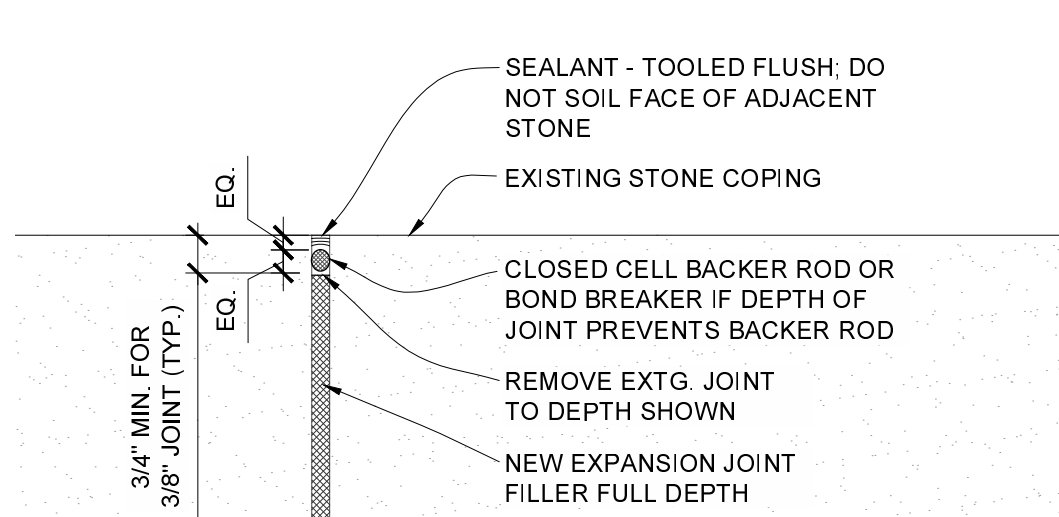


E4 TYP. STONE COPING HEAD JOINT DETAIL
SCALE: 3" = 1'-0"

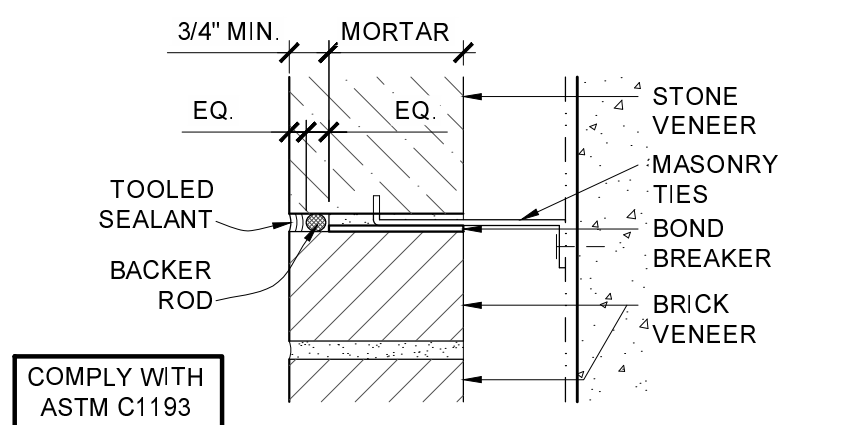


TYP. MASONRY JOINTS: STONE TO BRICK VENEER
SCALE: 3" = 1'-0"

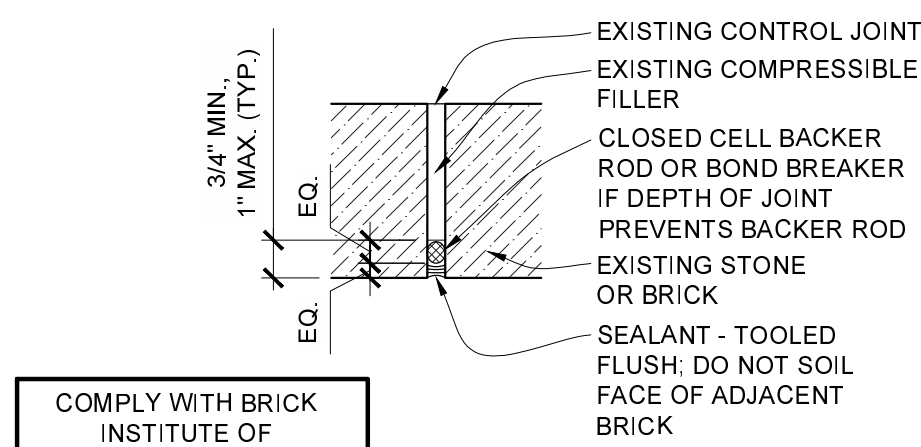


TYP. NEW CUT CONTROL JT. @ EXISTING MASONRY
SCALE: 3" = 1'-0"

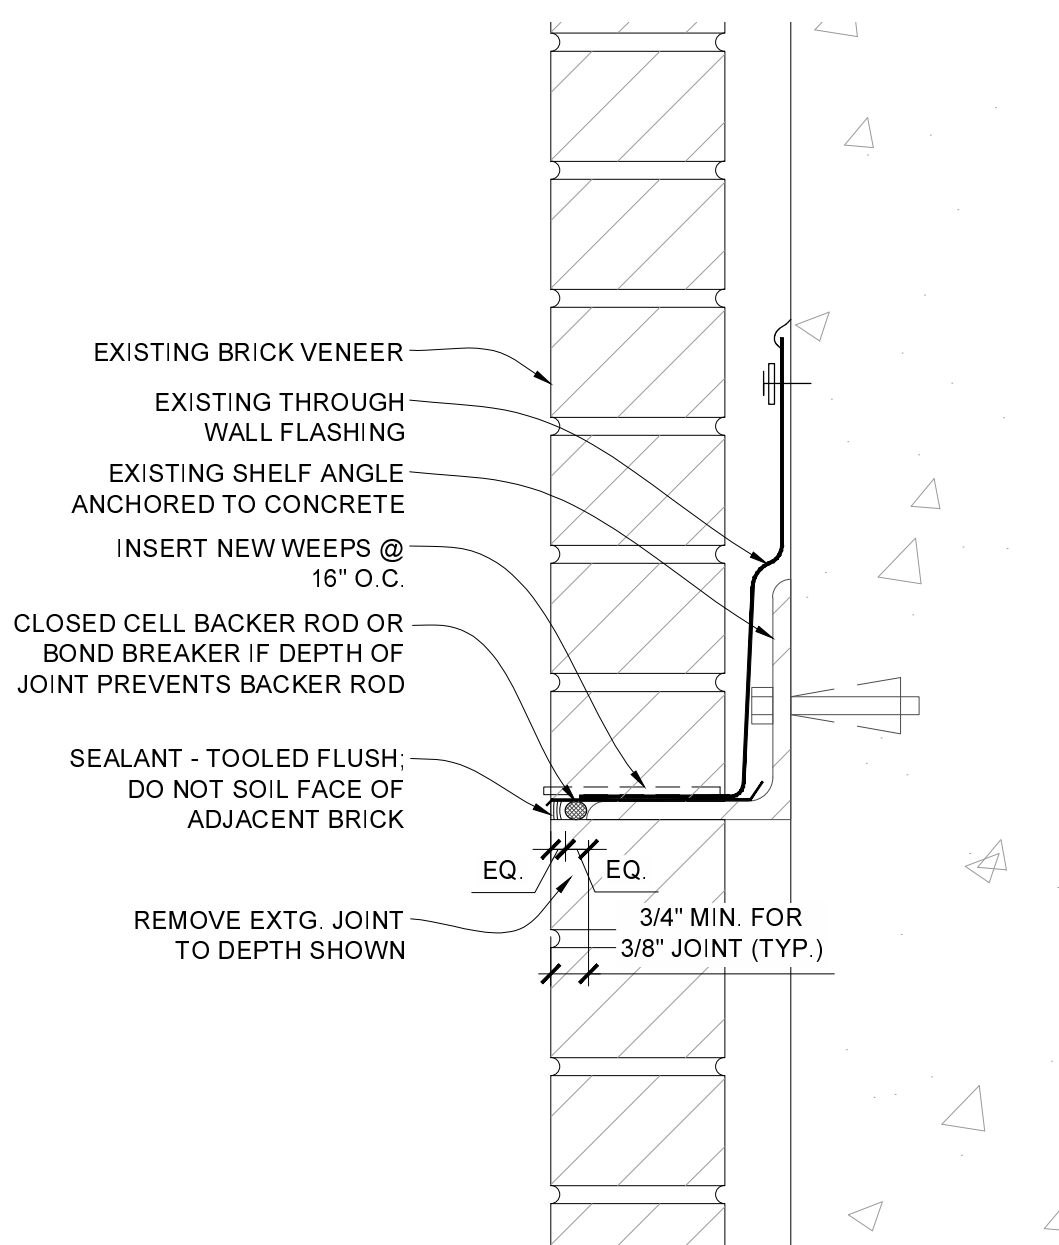


A4 **TYP. LEDGE ANGLE DETAIL**
SCALE: 3" = 1'-0"

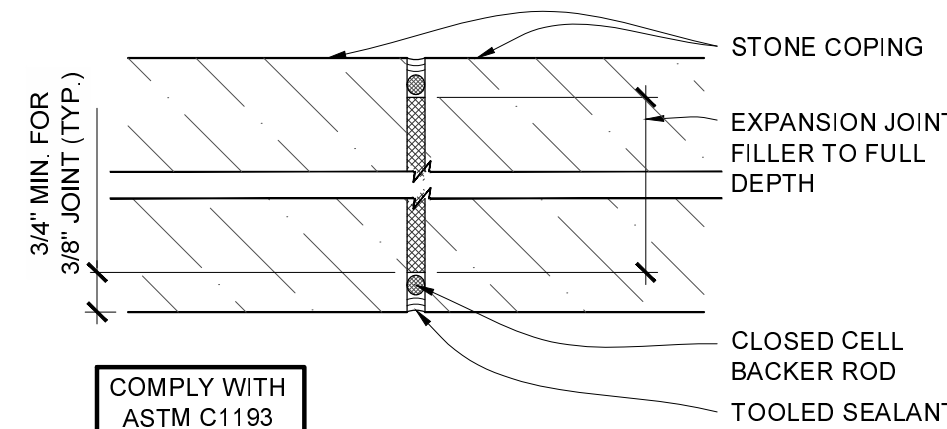

TYP. PLAN DETAIL: NEW MASONRY JOINTS AT STONE COPING
SCALE: 3" = 1'-0"

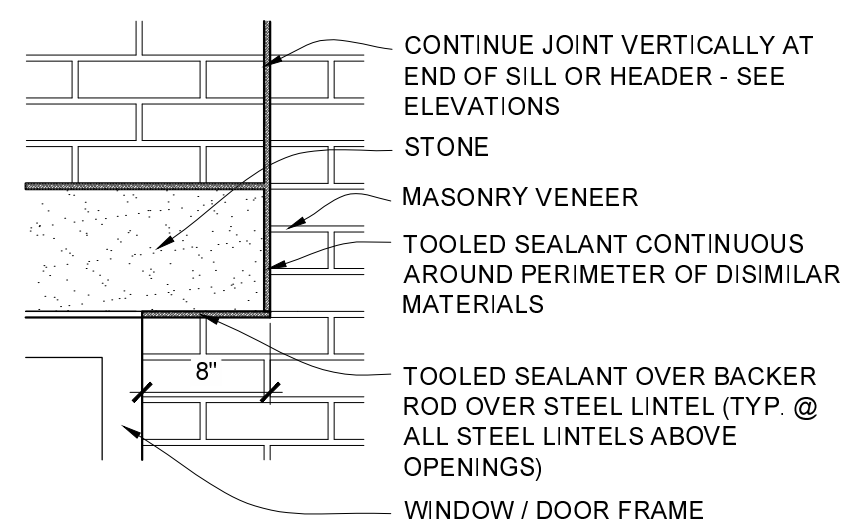


TYP. ELEVATION DETAIL: MASONRY JOINTS AT DISSIMILAR MATERIALS
SCALE: 1" = 1'-0"

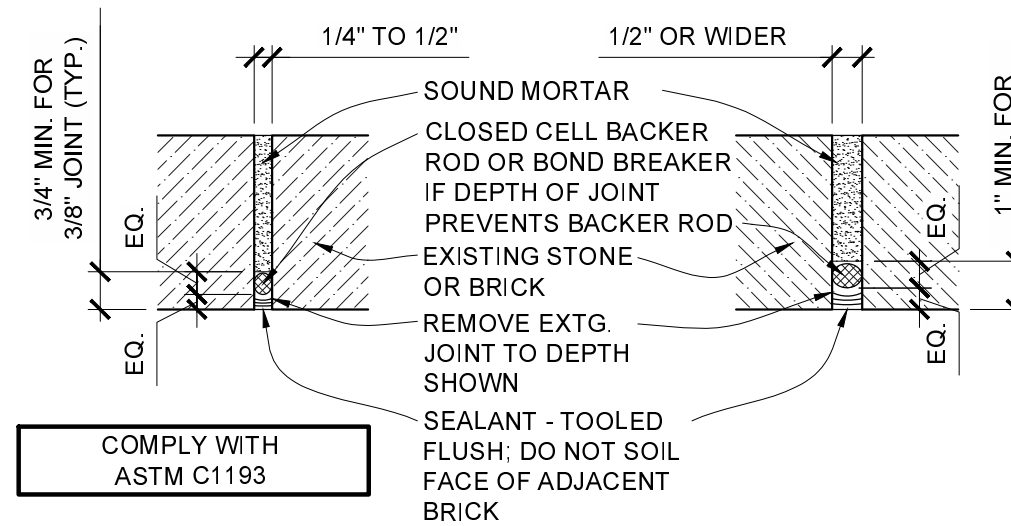

TYP. REPOINT SEALANT JOINT /
NEW "RAKE AND SEAL" JOINT @ EXISTING MASONRY



SCALE: 3" = 1'-0"

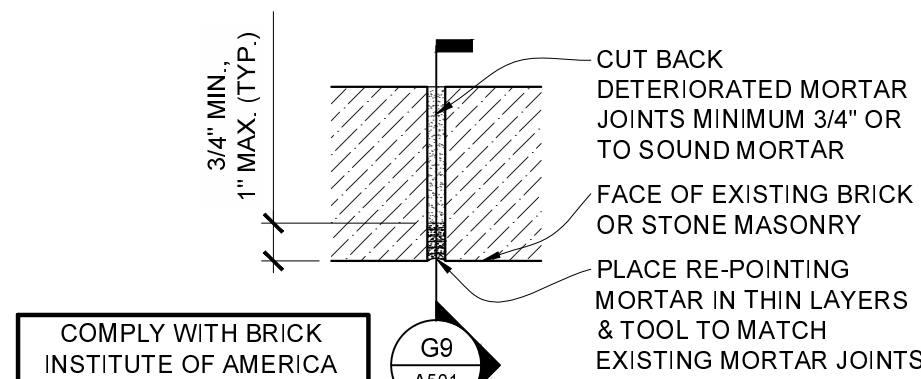

TYP. REPOINT MORTAR JOINT @ EXISTING MASONRY
SCALE: 3" = 1'-0"

GENERAL NOTES

1. FIELD VERIFICATION: INFORMATION CONTAINED IN THESE DRAWINGS IS BASED ON EXISTING DOCUMENTS. THE INFORMATION CONTAINED HEREIN MAY REQUIRE ADJUSTMENTS OR MODIFICATIONS TO CONFORM WITH EXISTING CONDITIONS IN CASES WHERE CHANGES IN DETAILS ARE NECESSARY. THESE DRAWINGS CONVEY THE DESIGN INTENT ONLY.
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5. FLASHING DETAILS SHOWN ARE BASED ON STANDARD DETAILS FROM THE SHEETMETAL AND AIR CONDITIONING CONTRACTORS NATIONAL ASSOCIATION (SMACNA). NOTIFY OWNER'S REPRESENTATIVE OR FABRICATOR OF INSTALLATION REQUIREMENTS THAT DIFFER FROM THOSE SHOWN. DO NOT PROCEED WITH WORK UNTIL INSTRUCTIONS ARE RECEIVED FROM OWNER'S REPRESENTATIVE.
6. PERFORM ALL TIEOUTPOINTING WORK IN ACCORDANCE WITH THE BRICK INDUSTRY ASSOCIATION (BIA) TECH NOTES PUBLICATION 46, AND THE CONTRACT DOCUMENTS, WHICHEVER IS THE MOST STRINGENT.
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13. LEAVE AREA CLEAN AND FREE OF DEBRIS AT THE END OF EACH DAY.
14. UNLESS OTHERWISE NOTED OR SHOWN, DIMENSIONS ARE PROVIDED FOR PURPOSES OF OBTAINING APPROXIMATE QUANTITIES ONLY. FIELD VERIFY ALL QUANTITIES.

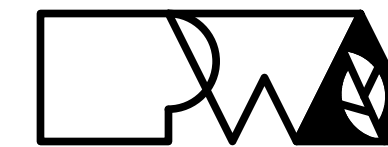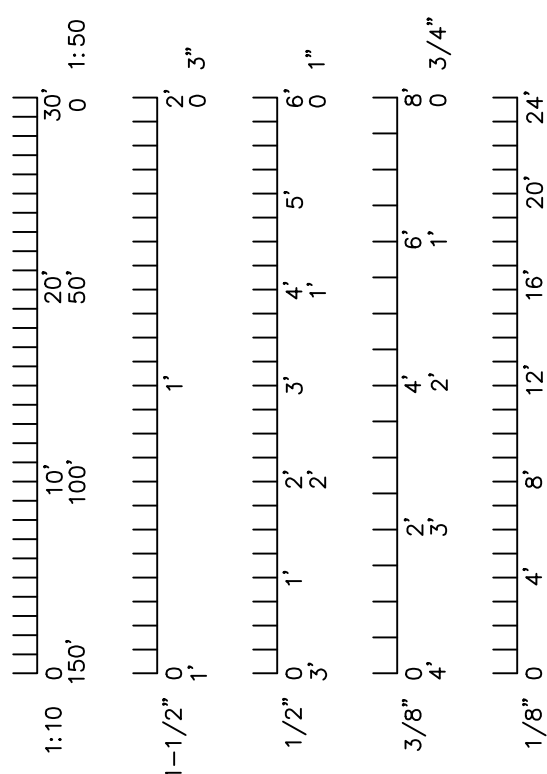

Peckham & Wright Architects, Inc., d.b.a.
PWArchitects, Inc.
2120 Forum Blvd., Ste. 101
Columbia, Missouri 65203
PWArchitects.com | 573.449.2683



Project CP252341
VARIOUS LOCATIONS -
HATCH & SCHURZ HALL
TUCK POINTING
COLUMBIA, MO
University of Missouri
or: The Curators of the University of Missouri

Drawn:	Project Number:	
ER	202509	
Checked:	CAD File Name (Number):	
ER	A501.DWG	
Drawing Title:		
DETAILS		
No.	Revisions:	Date:
Submission Date:		Drawing Number:
2025.11.21		A501
Plot Date:		
2025.11.21		

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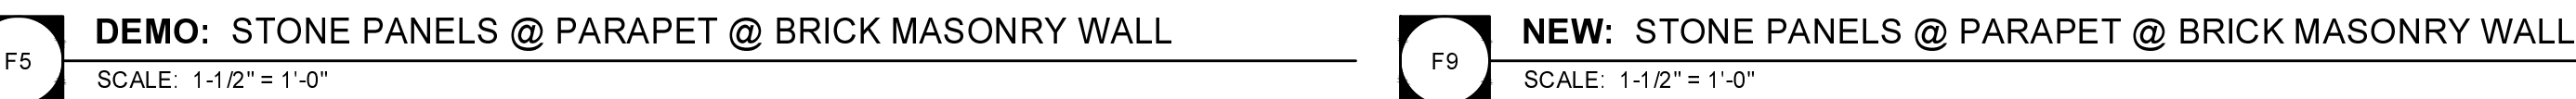
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Drawn:	Project Number:
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Drawing Title:
DETAILS

Submission Date:	Drawing Number:
2025.11.21	A502
Plot Date:	
2025.11.21	



NEW: STONE PANELS @ PARAPET @ WINDOW
SCALE: 1-1/2" = 1'-0"

